### **VIATIONS**

A	BBREV
AC A/C ACD ACT AD ADD AFF ALT ALUM ALZN AP ARCH ASB ASC	AT AND ACOUSTICAL AIR CONDITIONING ACCESS DOOR ACOUSTICAL TILE AREA DRAIN ADDENDUM ABOVE FINISHED FLOOR ALTERNATE ALUMINUM ALUMINUM ZINC GALVANIZED ACCESS PANEL ARCHITECT / ARCHITECTURAL ASBESTOS ABOVE SUSPENDED CEILING ASPHALT
BM BMO BO BRK	BUILDING BEAM BRICK MASONRY OPENING BOTTOM OF BRICK BUILT-UP ROOFING
COL CONC CONST CONT CONTR CPT CRG CU.IN.	
DEMO DIA DIFF DIM DPR DR	DETAIL DEMOLISH, DEMOLITION DIAMETER DIFFUSER DIMENSION DAMPER DOOR DRAWING
ELC ELEC ELEV ENT EP	EACH EXPANSION JOINT ELEVATION ELECTRICAL CONTRACTOR ELECTRICAL ELEVATION ENTRANCE ELECTRIC PANELBOARD EQUAL

EQ

EQP

ETR

EQUAL

EXISTING

EXIST EXISTING

**EQUIPMENT** 

EXISTING TO REMAIN

HOLLOW METAL **HEIGHT** HEATING/VENTILATING/AIR CONDITIONING INCAN INCANDESCENT INFORMATION INSULATED / INSULATION JANITOR'S CLOSET KITCHEN POUND **MAXIMUM** MECHANICAL CONTRACTOR **MECHANICAL MISCELLANEOUS** 

FLOORING CONTRACTOR

FIRE EXTINGUISHER

FINISHED FLOOR

FLOOR DRAIN

**FLASHING** 

FLUOR FLUORESCENT

FURRED

KIT

**ELEVATION (LEVEL** 

**GENERAL CONTRACTOR** 

**GYPSUM WALL BOARD** 

**HOLLOW CORE** 

**MATERIA** MULLION NUMBER NOT TO SCALE

NO OC ON CENTER OPN'G OPENING

PLUMBING CONTRACTOR **PHOTOVOLTAIC** REINFORCED CONCRETE REINFORCEMENT

**ROOF LADDER ROUGH OPENING ROOF VENT** SOLID CORE SCHED SCHEDULE STORM DRAIN SECTION SIMILAR SKYLIGHT STARTING POINT **SPECIFICATION** SQUARE STAINLESS STEEL STANDARD

> STEEL SUSPENDED

PLBG

PLYWD

PI UMBING

PLYWOOD

**QUARRY TILE** 

RETURN AIR

RUBBER BASE

RUBBER TILE

ROOF DRAIN

REFERENCE

REGISTERED

REMOVE REQUIRED

RETURN

**REVISION ROOF HATCH** 

POINT PAINTED PARTITION

SYMMETRICAL TONGUE & GROOVE TOP OF CURB TELEPHONE TOP OF FOOTING TEMPERED GLASS TOP OF SLAB TOP OF STEEL TERRAZZO TILE TOP OF WALL **TYPICAL** 

> NOTED **VINYL BASE** VERIFY IN FIELD **VENT STACK OR PIPE** VINYL TILE

**UNLESS OTHERWISE** 

WIRE GLASS



# **GRIGG'S CORNER**

**54-60 WITHERSPOON STREET** PRINCETON, NJ 08542

### **GENERAL NOTES**

ALL MATERIAL. ASSEMBLIES. FORMS AND METHODS OF CONSTRUCTION AND SERVICE EQUIPMENT SHALL COMPLY WITH THE REQUIREMENTS OF THE INTERNATIONAL BUILDING CODE 2018 - NEW JERSEY EDITION, THE UNIFORM CONSTRUCTION CODE (NJAC 5:23) THE INTERNATIONAL CODE COUNCIL (ICC), THE AMERICANS WITH DISABILITY ACT. (ADA) AND ANY OTHER APPLICABLE CODES.

THE GENERAL CONTRACTOR SHALL FURNISH ADEQUATE LIABILITY NSURANCE AND BONDING AS REQUIRED BY THE OWNER AND MUNICIPAL REGULATIONS SPECIFICATIONS AND GENERAL CONDITIONS.

ANY DIMENSIONAL DISCREPANCIES BETWEEN THE PLANS. SECTIONS. ELEVATIONS AND DETAILS MUST BE BROUGHT TO THE ATTENTION OF THE ARCHITECT BY THE CONTRACTOR FOR RESOLUTION PRIOR TO THE START OF WORK.

ANY INCONSISTENCIES IN THE NOTES, SYMBOLS, LEGENDS MUST BE BROUGHT TO THE ATTENTION OF THE ARCHITECT BY THE CONTRACTOR FOR RESOLUTION PRIOR TO THE START OF WORK.

ANY INCONSISTENCIES BETWEEN THE DRAWINGS AND TECHNICAL SPECIFICATIONS MUST BE BROUGHT TO THE ATTENTION OF THE ARCHITECT BY THE CONTRACTOR FOR RESOLUTION PRIOR TO THE START OF WORK.

ALL CONTRACTORS AND SUBCONTRACTORS MUST CHECK AND VERIFY ALL EXISTING CONDITIONS AND DIMENSIONS AND REPORT ANY DISCREPANCIES TO THE ARCHITECT PRIOR TO THE START OF

ALL CONTRACTORS SHALL MAINTAIN SAFE EGRESS AT ALL TIMES TO ALL-BUILDING EXITS. ALL EXITS SHALL BE KEPT READILY ACCESSIBLE AND UNOBSTRUCTED AT ALL TIMES. IF IT IS NECESSARY TO PROVIDE 18. ALL COLORS TO BE SELECTED AND APPROVED BY THE ARCHITECT. TEMPORARY PATHS OF EGRESS, ALL DETAILS OF SAME SHALL BE APPROVED BY LOCAL FIRE DEPARTMENT AS WELL AS OWNER.

DAMAGE TO PROPERTY SHALL BE CORRECTED BY THE CONTRACTOR SO INVOLVED. IF AREA IS NOT REPAIRED IN A REASONABLE TIME, OWNER HAS THE RIGHT TO TAKE OVER THE WORK WITH ITS OWN FORCES AND ANY COST WILL BE DEDUCTED AGAINST THE CONTRACTOR'S CONTRACT.

THE GENERAL CONTRACTOR SHALL BE REQUIRED TO ESTABLISH STAGING AND PHASING PLANS TO COORDINATE WITH ALL SUB CONTRACTORS. SUCH PLANS SHALL BE UPDATED PERIODICALLY. PLANS SHALL SHOW STORAGE AREAS, TRAILERS, FENCES, LOCATION OF CRANES AND/OR HOISTS THAT MAY BE REQUIRED, TEMPORARY FACILITIES AND ACCESS ROUTES TO AND WITHIN THE BUILDING. SUCH A PLAN SHALL BE SUBMITTED BEFORE THE START OF THE PROJECT. SUCH STAGING AND PHASING PLAN SHALL ALSO COMPLY WITH THE WORK RULES AS WELL AS THE GENERAL STAGING PLAN ESTABLISHED BY THE OWNER, ARCHITECT AND OWNER'S REPRESENTATIVE.

GENERAL CONTRACTOR SHALL PROVIDE 2 EMPLOYEE TOILETS AT STAGING AREA FOR THE USE OF ALL CONTRACTORS' EMPLOYEES OR GAIN PERMISSION FROM BUILDING MANAGEMENT FOR USE OF BUILDING TOILETS.

PARKING LOCATIONS FOR CONTRACTORS' VEHICLES, ACCEPTABLE 25. SEE FINISH SCHEDULE FOR PAINTING; OTHER PAINTING SCOPE SHALL HOURS FOR DEMOLITION, CONSTRUCTION, AND MATERIAL DELIVERY OR REMOVAL, AND ANY OTHER SPECIAL REQUIREMENTS ARE TO BE VERIFIED WITH THE OWNER, THE OWNER'S REPRESENTATIVE PRIOR 26. WHERE FINISH FLOOR MATERIAL ENDS AT DOOR AND OPENINGS AND IS TO THE START OF WORK.

GENERAL CONTRACTOR SHALL MAINTAIN A DAILY REPORT COMPLETED, MATERIALS DELIVERED, WEATHER CONDITIONS AND ANY UNUSUAL EVENTS. A COPY OF SUCH A REPORT SHALL BE PROVIDED TO THE ARCHITECT AND OWNERS REPRESENTATIVE ON A 28. WHERE THERE ARE SMALL GAPS AT STONE, TILE AND WALLS, BI-WEEKLY BASIS AND WHEN REQUESTED.

. ALL CONTRACTORS SHALL COMPLY WITH OSHA RULES & REGULATIONS

UNLESS A LONGER GUARANTEE IS SPECIFIED, ALL WORK SHALL BE GUARANTEED AGAINST DEFECTS IN ACCORDANCE WITH THE

REQUIREMENTS OF THE GENERAL CONDITIONS. ANY PORTIONS OF THE WORK WHICH DEVELOP DEFECTS DURING THE GUARANTEE PERIOD SHALL BE REPLACED IN A MANNER SATISFACTORY TO THE ARCHITECT, TENANT AND OWNER

15 IN THE EVENT OF CONFLICT AMBIGUITY INCONSISTENCIES AND/OR UNCLEAR CIRCUMSTANCES BETWEEN ANY OF THE REQUIREMENTS OF THE CONTRACT DOCUMENTS AND APPLICABLE STANDARDS, CODES. DRDINANCES. OR OTHER REQUIREMENTS OF THE CONTRACT DOCUMENTS, THE REQUIREMENT THAT IS MOST INCLUSIVE AND OF HIGHEST QUANTITY AND/OR QUALITY AND/OR COST SHALL GOVERN. THE CONTRACTOR SHALL (1) PROVIDE THE BETTER QUALITY OR GREATER QUANTITY OF WORK,

(2) COMPLY WITH THE MORE STRINGENT REQUIREMENT; EITHER OR BOTH IN ACCORDANCE WITH THE ARCHITECT'S INTERPRETATION. THE CONTRACTOR HEREWITH AGREES THAT NO EXTRA COMPENSATION SHALL BE AWARDED TO HIM, SINCE HE HEREWITH RECEIVED SPECIFIC INSTRUCTIONS TO THE PROCEDURE AND VALUES OF THE WORK. THE TERMS AND CONDITIONS OF THIS PARAGRAPH, HOWEVER, SHALL NOT RELIEVE THE CONTRACTOR OF ANY OF THE OBLIGATIONS SET FORTH IN REVIEW OF THE CONTRACT DOCUMENTS AND FIELD CONDITIONS.

CONTRACTOR TO PROVIDE SPECIFICATIONS, SAMPLES, CUT SHEETS, AND FULLY COORDINATED SHOP DRAWINGS FOR ALL ASSOCIATED NEW AND EXISTING ELEMENTS INCLUDING BUT NOT LIMITED TO: ALL HARDWARE, DOORS, WINDOWS, CEILINGS, FINISHES, FIXTURES AND EQUIPMENT FOR APPROVAL.

17. SHOP DRAWINGS COORDINATED BY THE GENERAL CONTRACTOR SHALL BE SUBMITTED TO THE ARCHITECT FOR APPROVAL BEFORE FABRICATION IS STARTED.

SAMPLES OF ALL FINISHES SPECIFIED SHALL BE SUBMITTED TO THE ARCHITECT PRIOR TO COMMENCEMENT OF WORK. UPON REQUEST, SAMPLES OF ACCEPTED PAINT SHALL BE MOCKED-UP ON SITE FOR THE ARCHITECT'S FINAL APPROVAL AT NO EXTRA COST TO THE OWNER.

19. DIMENSIONS OF NEW WALLS ARE TAKEN TO FACE OF FINISH UNLESS

20. DIMENSIONS ARE TO FACE OF GYPSUM WALL BOARD AT ROOMS WITH PAINTED OR EXPOSED GYPSUM BOARD U.O.N.

21. ALL SYMBOLS AND FINISH SCHEDULE DESIGNATIONS OF MATERIALS INDICATE NEW MATERIAL UNLESS OTHERWISE NOTED.

22. ALL NEW INSTALLED EQUIPMENT SHALL BE UL LABELED. ALL LIGHTING FIXTURES SHALL BE REVIEWED AND APPROVED BY ARCHITECT, LIGHTING CONSULTANT AND CONSULTING ENGINEER AND SHALL HAVE

EXTINGUISHER. SMOKE FROM WELDING SHALL BE VENTED DIRECTLY TO EXTERIOR WHEN BUILDING IS OCCUPIED. 24. ALL WELDS SHALL RECEIVE TWO (2) COATS OF RUSTPROOFING PAINT.

23. ALL FIELD WELDING WORK SHALL BE ACCOMPANIED WITH A FIRE

BE FOUND ON DRAWINGS.

HIGHER THAN THE ADJACENT FLOORING MATERIAL, A REDUCING STRIP SHALL BE USED OF THE SPECIFIED TRANSITION MATERIAL.

INDICATING TRADE(S) WORKED AND NUMBER OF WORKERS, WORK 27. A WET SAW SHALL BE USED TO CUT ALL STONE TILE & CERAMIC TILES. USE OF MANUAL CUTTING TOOLS IS UNACCEPTABLE.

> CAULKING OF SIMILAR COLOR SHALL BE USED. COLOR TO BE VERIFIED AND APPROVED BY ARCHITECT.

29. ALL CONTRACTORS ARE ASSUMED TO HAVE THOROUGHLY REVIEWED GENERAL CONDITIONS OF THE CONTRACT FOR CONSTRUCTION PRIOR TO START OF WORK AND EXPECTED TO FULLY COMPLY WITH THE REQUIREMENTS THEREIN AND ANY OTHER REQUIREMENTS.

30. GENERAL CONTRACTOR IS RESPONSIBLE TO FIRESTOP. CAULK AND SEAL PENETRATIONS PERFORMED BY SUB CONTRACTORS UNLESS ALTERNATE AGREEMENT IS IN PLACE. CAULK TO BE LOW

31. GENERAL CONTRACTOR IS RESPONSIBLE FOR COORDINATING CONSTRUCTION DOCUMENTS FROM ALL TRADES TO LOCATE ANY AND ALL DUCT, PIPE, CONDUIT, ELECTRIC PENETRATIONS OR SLEEVES IN CONSTRUCTION AND COORDINATING THESE LOCATIONS WITH OTHER TRADES AND THEIR SHOP DRAWINGS BEFORE WALLS AND PARTITIONS ARE PUT IN PLACE.

32. CONTRACTOR IS REQUIRED TO HAVE ON SITE PRE-INSTALLATION TRAINING WITH THE MANUFACTURER OR MANUFACTURER'S REPRESENTATIVE FOR DOOR HARDWARE PRIOR TO OR IN CONJUNCTION WITH HANGING EACH HARDWARE SET. CONTRACTOR TO NOTIFY ARCHITECT AND OWNER WHEN TRAINING WILL OCCUR.

33. THERE SHOULD BE NO MORE THAN 1/16" EASED EDGES ON ALL NEW WOOD TRIM IF SPECIES OF WOOD REQUIRES EASED EDGES, PROVIDE A SAMPLE FOR ARCHITECT'S APPROVAL.

34. ALL WOOD PANELS ARE EDGE BANDED WITH MINIMUM 1/4" SOLID STOCK VENEER EXTENDING OVER EDGE BAND UNLESS OTHERWISE NOTED.

35. EXISTING AND NEW DOORS SHALL BE UNDERCUT 1/4" HIGHER THAN THE FINISH FLOOR, COORDINATE WITH AIR TRANSFER REQUIREMENTS IN MECHANICAL SECTION, U.O.N.

36. ALL TRIM (RECESSED FIXTURES). DIFFUSERS, REFLECTORS, SPRINKLER COVERS, SWITCHES, OUTLETS, COVERS, LIGHT TRACKS, AND TRACK LIGHTS AND OTHER MOUNTED DEVICES ARE TO BE PAINTED TO MATCH THE SURFACE IN WHICH THEY SIT OR PROVIDED IN A COLOR TO BE SELECTED BY ARCHITECT.

37. DO NOT SCALE THE DRAWINGS. FOLLOW DIMENSIONS INDICATED ON DRAWINGS. ALL DIMENSIONS ARE TO BE VERIFIED ON FIELD, AS DIMENSIONS SHOWN ARE FOR REFERENCE ONLY. IF CLARIFICATION IS NEEDED IN REFERENCE TO A PARTICULAR DIMENSION, CONTACT THE ARCHITECT.

38. CONTRACTOR TO PROVIDE FIRE EXTINGUISHERS FOR EMERGENCY DURING CONSTRUCTION

39. NO USE OF TOBACCO PRODUCTS IS PERMITTED ON THE CONSTRUCTION SITE.

40. CONTRACTOR TO PROVIDE ADDITIONAL REINFORCEMENTS FOR SUSPENDED CEILING SYSTEMS (INC. ACOUSTIC) AS RECOMMENDED BY MANUFACTURER AT LOCATIONS OF LIGHTS AND DEVICE PENETRATIONS.

ALL WORK PERTAINING TO THESE DRAWINGS SHALL BE PERFORMED IN ACCORDANCE WITH ALL APPLICABLE STATE AND LOCAL CODES AND IN AGREEMENT WITH ALL AGENCIES HAVING JURISDICTION. ALL TRADE CONTRACTORS SHALL BE LICENSED AND INSURED TO PERFORM THE WORK OUTLINED IN THE CONSTRUCTION DOCUMENTS.

42. GYPSUM BOARD SHALL BE APPLIED TO ALL METAL FRAMING PRIOR TO ANY OTHER FINISHES BEING ATTACHED.

43. ALL GYPSUM BOARD SHALL BE FIRE RATED TYPE (TYPE X).

CONTRACTOR.

45. BENJAMIN MOORE, SHERWIN WILLIAMS, AND MYTHIC PAINTS ARE ACCEPTABLE PAINT MANUFACTURERS ALL OTHERS MUST HAVE

44. ALL ROUGH FRAMING AND BLOCKING SHALL BE FIRE-RETARDANT-

TO BE USED THE GENERAL CONTRACTOR SHALL INFORM THE ARCHITECT OF THE COMPLETION OF DEMOLITION, AND SHALL INSPECT THE WORK AREA WITH THE ARCHITECT TO IDENTIFY CONFLICTS PRIOR TO PROCEEDING WITH WORK. ALL CONFLICTS DISCOVERED SHALL BE INCORPORATED INTO THE SHOP DRAWINGS BY THE GENERAL

THE APPROVAL OF THE ARCHITECT. ONLY NO-VOC PAINTS ARE

**VICINITY MAP** 

**PROJECT** 

LOCATION

**KEY PLAN** 

A Little Taste of Cuba

	SHEET NAME
ARCHITECTURE	
T1-0	COVER SHEET & GENERAL NOTES
T1-1	EXISTING SITE PHOTOGRAPHS
A0-1	SITE PLANS AND AREA CALCULATIONS
A0-2	LIFE SAFETY PLANS & CODE INFO
A1-0	BASEMENT PLAN
A1-1	GROUND FLOOR PLAN
A1-2	SECOND FLOOR PLAN
A1-3	THIRD FLOOR PLAN
A1-4	ROOF PLAN
A3-1	SITE ELEVATIONS
A3-2	EXTERIOR ELEVATIONS
A3-3	EXTERIOR ELEVATIONS
A6-1	SIGNAGE
A6-2	LIGHTING
CIVIL ENGINEER	RING
1	COVER SHEET
2	BOUNDARY AND TOPOGRAPHIC SURVEY
3	DEMOLITION PLAN
4	SITE PLAN
4A	TRUCK ACCESSIBILITY PLAN
5	GRADING AND DRAINAGE PLAN
6	UTILITIES PLAN
7	LANDSCAPE AND LIGHTING PLAN
8	SOIL EROSION AND SEDIMENT CONTROL PLAN AND NOTES
9	SESC DETAILS
10	CONSTRUCTION DETAILS
11	CONSTRUCTION DETAILS
12	CONSTRUCTION DETAILS

EA PROPERTIES LLC

LORI RABON

VICE PRESIDENT

PALMER SQUARE MANAGEMENT

APPROVED BY THE PLANNING BOARD OF PRINCETON AS A MAJOR SITE PLAN:

40 NASSAU STREET, PRINCETON, NJ 08542

PALMER SQUARE MANAGEMENT, LLC

OWNER:

ADDRESS:

APPLICANT:

**SIGNATURE** 

SECRETARY

**ENGINEER** 

**NEW JERSEY 08542** (T) 609 924 5004 CIVIL ENGINEER

AMERICAN METRO BLVD. SUITE 114, HAMILTON, NJ 08619 MECHANICAL AND PLUMBING

FIRE PROTECTION

ELECTRICAL.

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11-09-2020 MUNICIPAL REVIEW

STATE OF NEW JERSEY REGISTERED ARCHITECT

JOSHUA B. ZINDER NJ 15316 PROJECT NAME

**GRIGG'S** CORNER

54-60 WITHERSPOON STREET PRINCETON, NJ 08542

DRAWING NAME

**COVER SHEET &** 

**GENERAL NOTES** 

JL, MP PROJECT NO.: 21920 12/23/19 SCALE: SHEET NUMBER

# **LEGEND**

CONTRACT LIMIT LINE

EXISTING CONSTRUCTION TO REMAIN EXISTING CONSTRUCTION TO BE

**NEW PARTITION** 

SECTION / ELEVATION TAG

DEMOLISHED

**PARTITION TYPE** 

DOOR NUMBER

**DETAIL TAG** 

INTERIOR ELEVATION TAG

ROOM NAME AND NUMBER

## PROJECT SUMMARY

THIS PROJECT IS LOCATED IN THE CB CENTRAL BUSINESS DISTRICT IN DOWNTOWN PRINCETON. A NEW 3-STORY MIXED USE BUILDING IS PROPOSED FOR THE PROPERTY. THE GROUND FLOOR AND BASEMENT WILL BE M MERCANTILE USE, AND THE SECOND AND THIRD FLOORS WILL BE R-2 RESIDENTIAL USE. THE PROPERTY IS AT THE EDGE OF PALMER SQUARE, ACROSS FROM A MAIN PUBLIC SQUARE AND PUBLIC LIBRARY, AND ALONG A MAIN THOROUGHFARE, WITHERSPOON STREET.

FROM THE 19TH AND 20TH CENTURIES. THERE WILL BE 8 RESIDENTIAL UNITS CONSISTING OF 5 DUPLEXES AND 3 APARTMENT FLATS. THE REDEVELOPMENT ALSO PROPOSES TO MIMIC THE BUILDING FABRIC DIVERSITY OF PALMER SQUARE BY USE OF SETBACKS AND DIFFERING, COMPLEMENTARY FACADE MATERIALS BETWEEN BUILDING MASSINGS. THIS PROJECT WILL PROVIDE ADA ACCESSIBILITY FROM THE FRONT OF HULFISH AND WITHERSPOON STREET AS WELL AS FROM

REINSTATE THE HISTORICAL PROGRAMMATIC DIVERSITY OF THE SITE BY BRINGING BACK RESIDENTIAL AND MERCANTILE USES

THE PROJECT PROPOSED TO REDEVELOP THE SITE FROM A PAVED PARKING LOT. THE REDEVELOPMENT PROPOSES TO

THE REAR COURTYARD. NEW BIKE STORAGE AND CONVENIENT GARBAGE REMOVAL ARE PROPOSED IN THE REAR COURTYARD AND LOADING DOCK, RESPECTIVELY. THE GROUND FLOOR AND BASEMENT WILL BE CONSTRUCTED OF STEEL FRAMING. THE RESIDENTIAL UPPER LEVELS WILL

CONSIST OF CONVENTIONAL WOOD FRAMING WITH A FIRE SEPARATION BETWEEN USES. A RESIDNEITAL SPRINKLER SYSTEM WILL

BE INSTALLED. FIRE PROTECTION PRACTICES

THE BUILDING SHALL HAVE FIRE RATED CONSTRUCTION FOR WALLS AND FLOORS BETWEEN DWELLING UNITS AND CORRIDORS. ALL CORRIDORS, COMMON AREAS AND DWELLING UNITS SHALL BE PROVIDED WITH SMOKE DETECTORS AS PART OF THE SMOKE DETECTION SYSTEM. ALL DWELLING UNITS SHALL BE PROVIDED WITH PORTABLE FIRE EXTINGUISHERS.

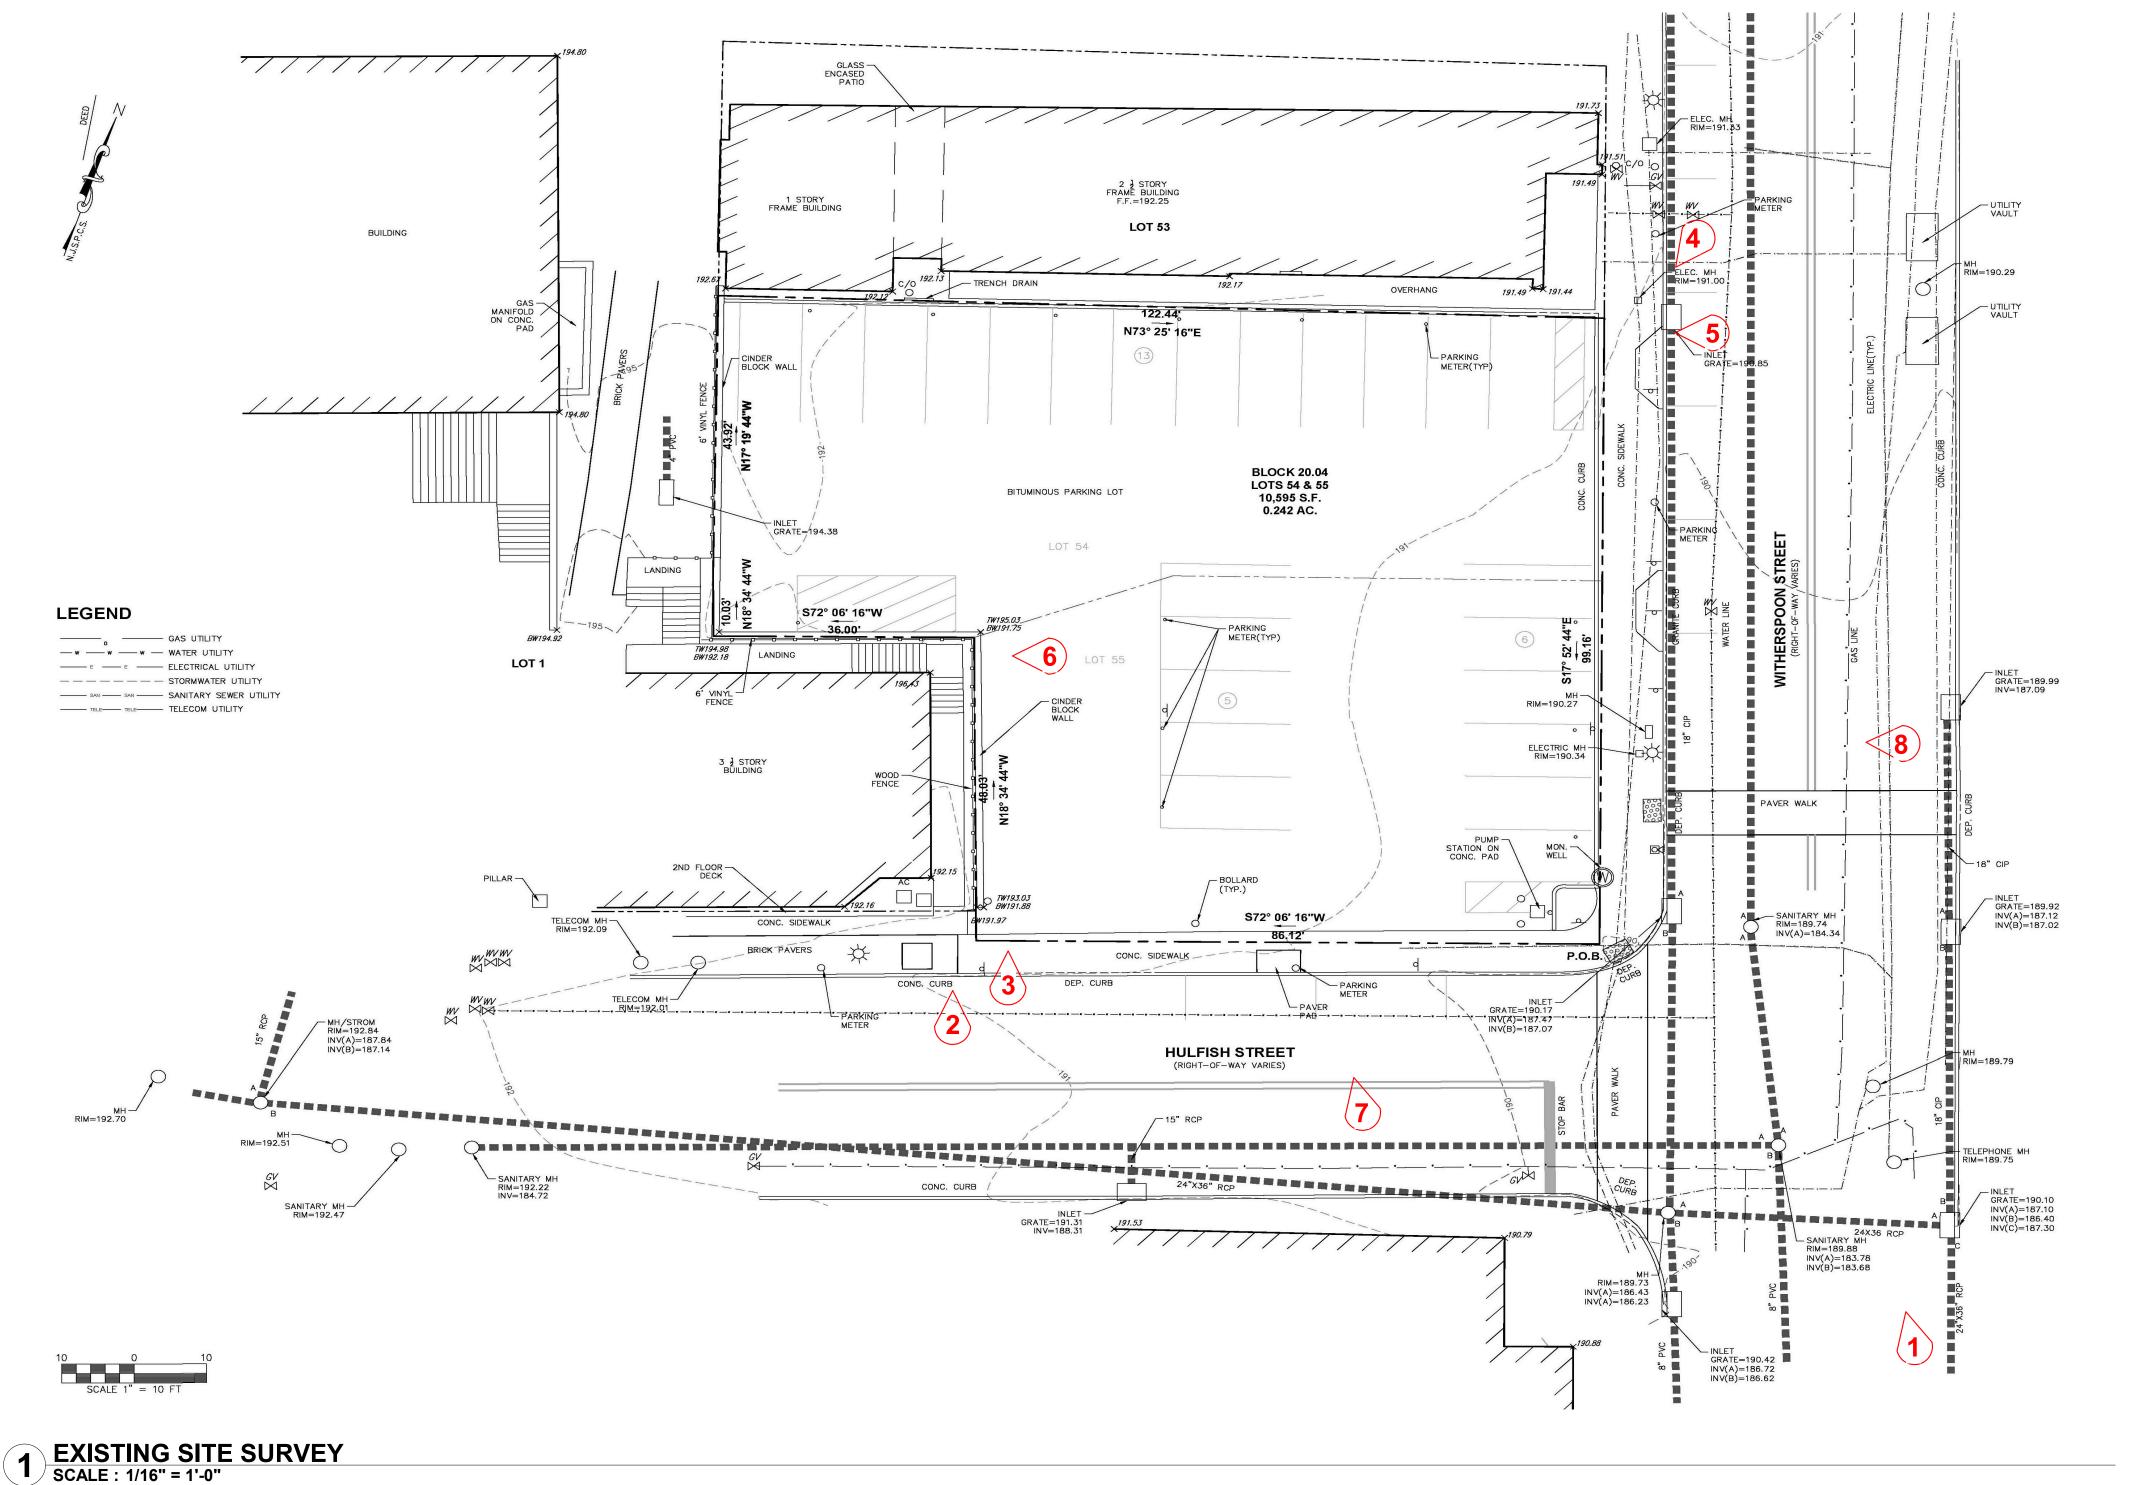




IMAGE #8\_NORTH LOT BOUNDARY



IMAGE #7\_NORTH LOT BOUNDARY

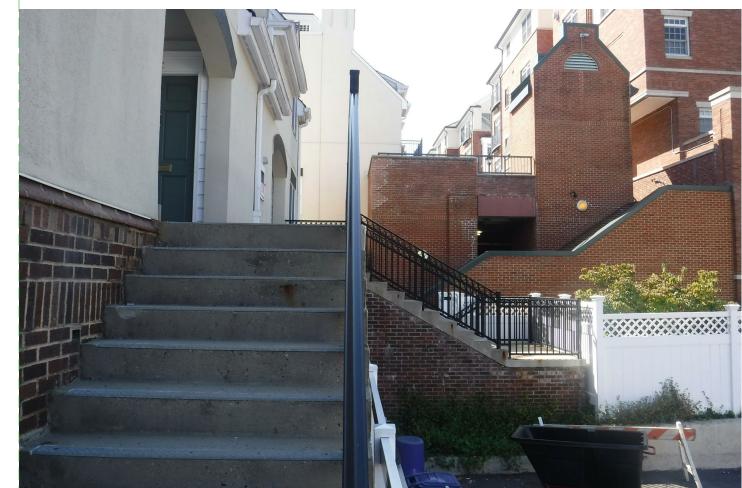


IMAGE #6\_VIEW FROM STAIRS @ SOUTH BOUNDARY

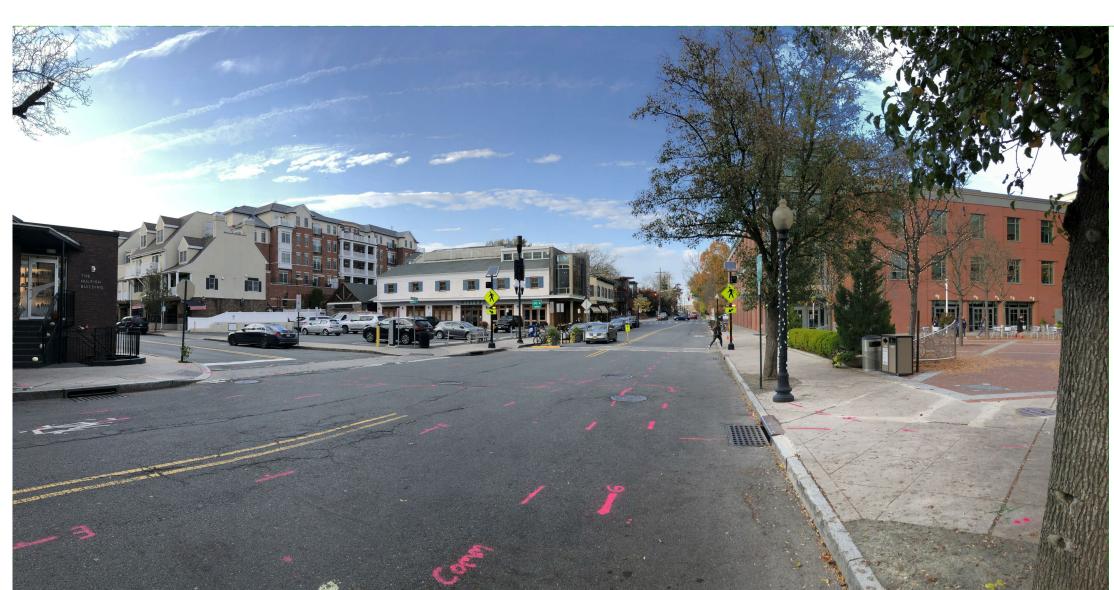


IMAGE #1\_CORNER YARD FACING PRINCETON PUBLIC LIBRARY FROM WITHERSPOON STREET

Palmer Square PRINCETON EST. 1957







IMAGE #5\_NORTH LOT BOUNDARY



 20 NASSAU STREET,
 SUITE 25

 PRINCETON,
 NEW JERSEY 08542

 (T) 609 924 5004
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For I P

MECHANICAL AND PLUMBING

200 AMERICAN METRO BLVD. SUITE 114, HAMILTON, NJ 08619 T. 609,454,3433, F. 908,238,9572

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11-09-2020 MUNICIPAL REVIEW
DATE ISSUED FOR
SEAL

STATE OF NEW JERSEY REGISTERED ARCHITECT JOSHUA B. ZINDER NJ 15316

## GRIGG'S CORNER

54-60 WITHERSPOON STREET PRINCETON, NJ 08542

DRAWING NAME

# **EXISTING SITE PHOTOGRAPHS**

DRAWN BY: JL, MP PROJECT NO.: 21920


DATE: 12-23-2019 SCALE: As indicated

SHEET NUMBER

T1-1

IMAGE #2\_SOUTH LOT BOUNDARY

IMAGE #3\_SOUTH LOT BOUNDARY

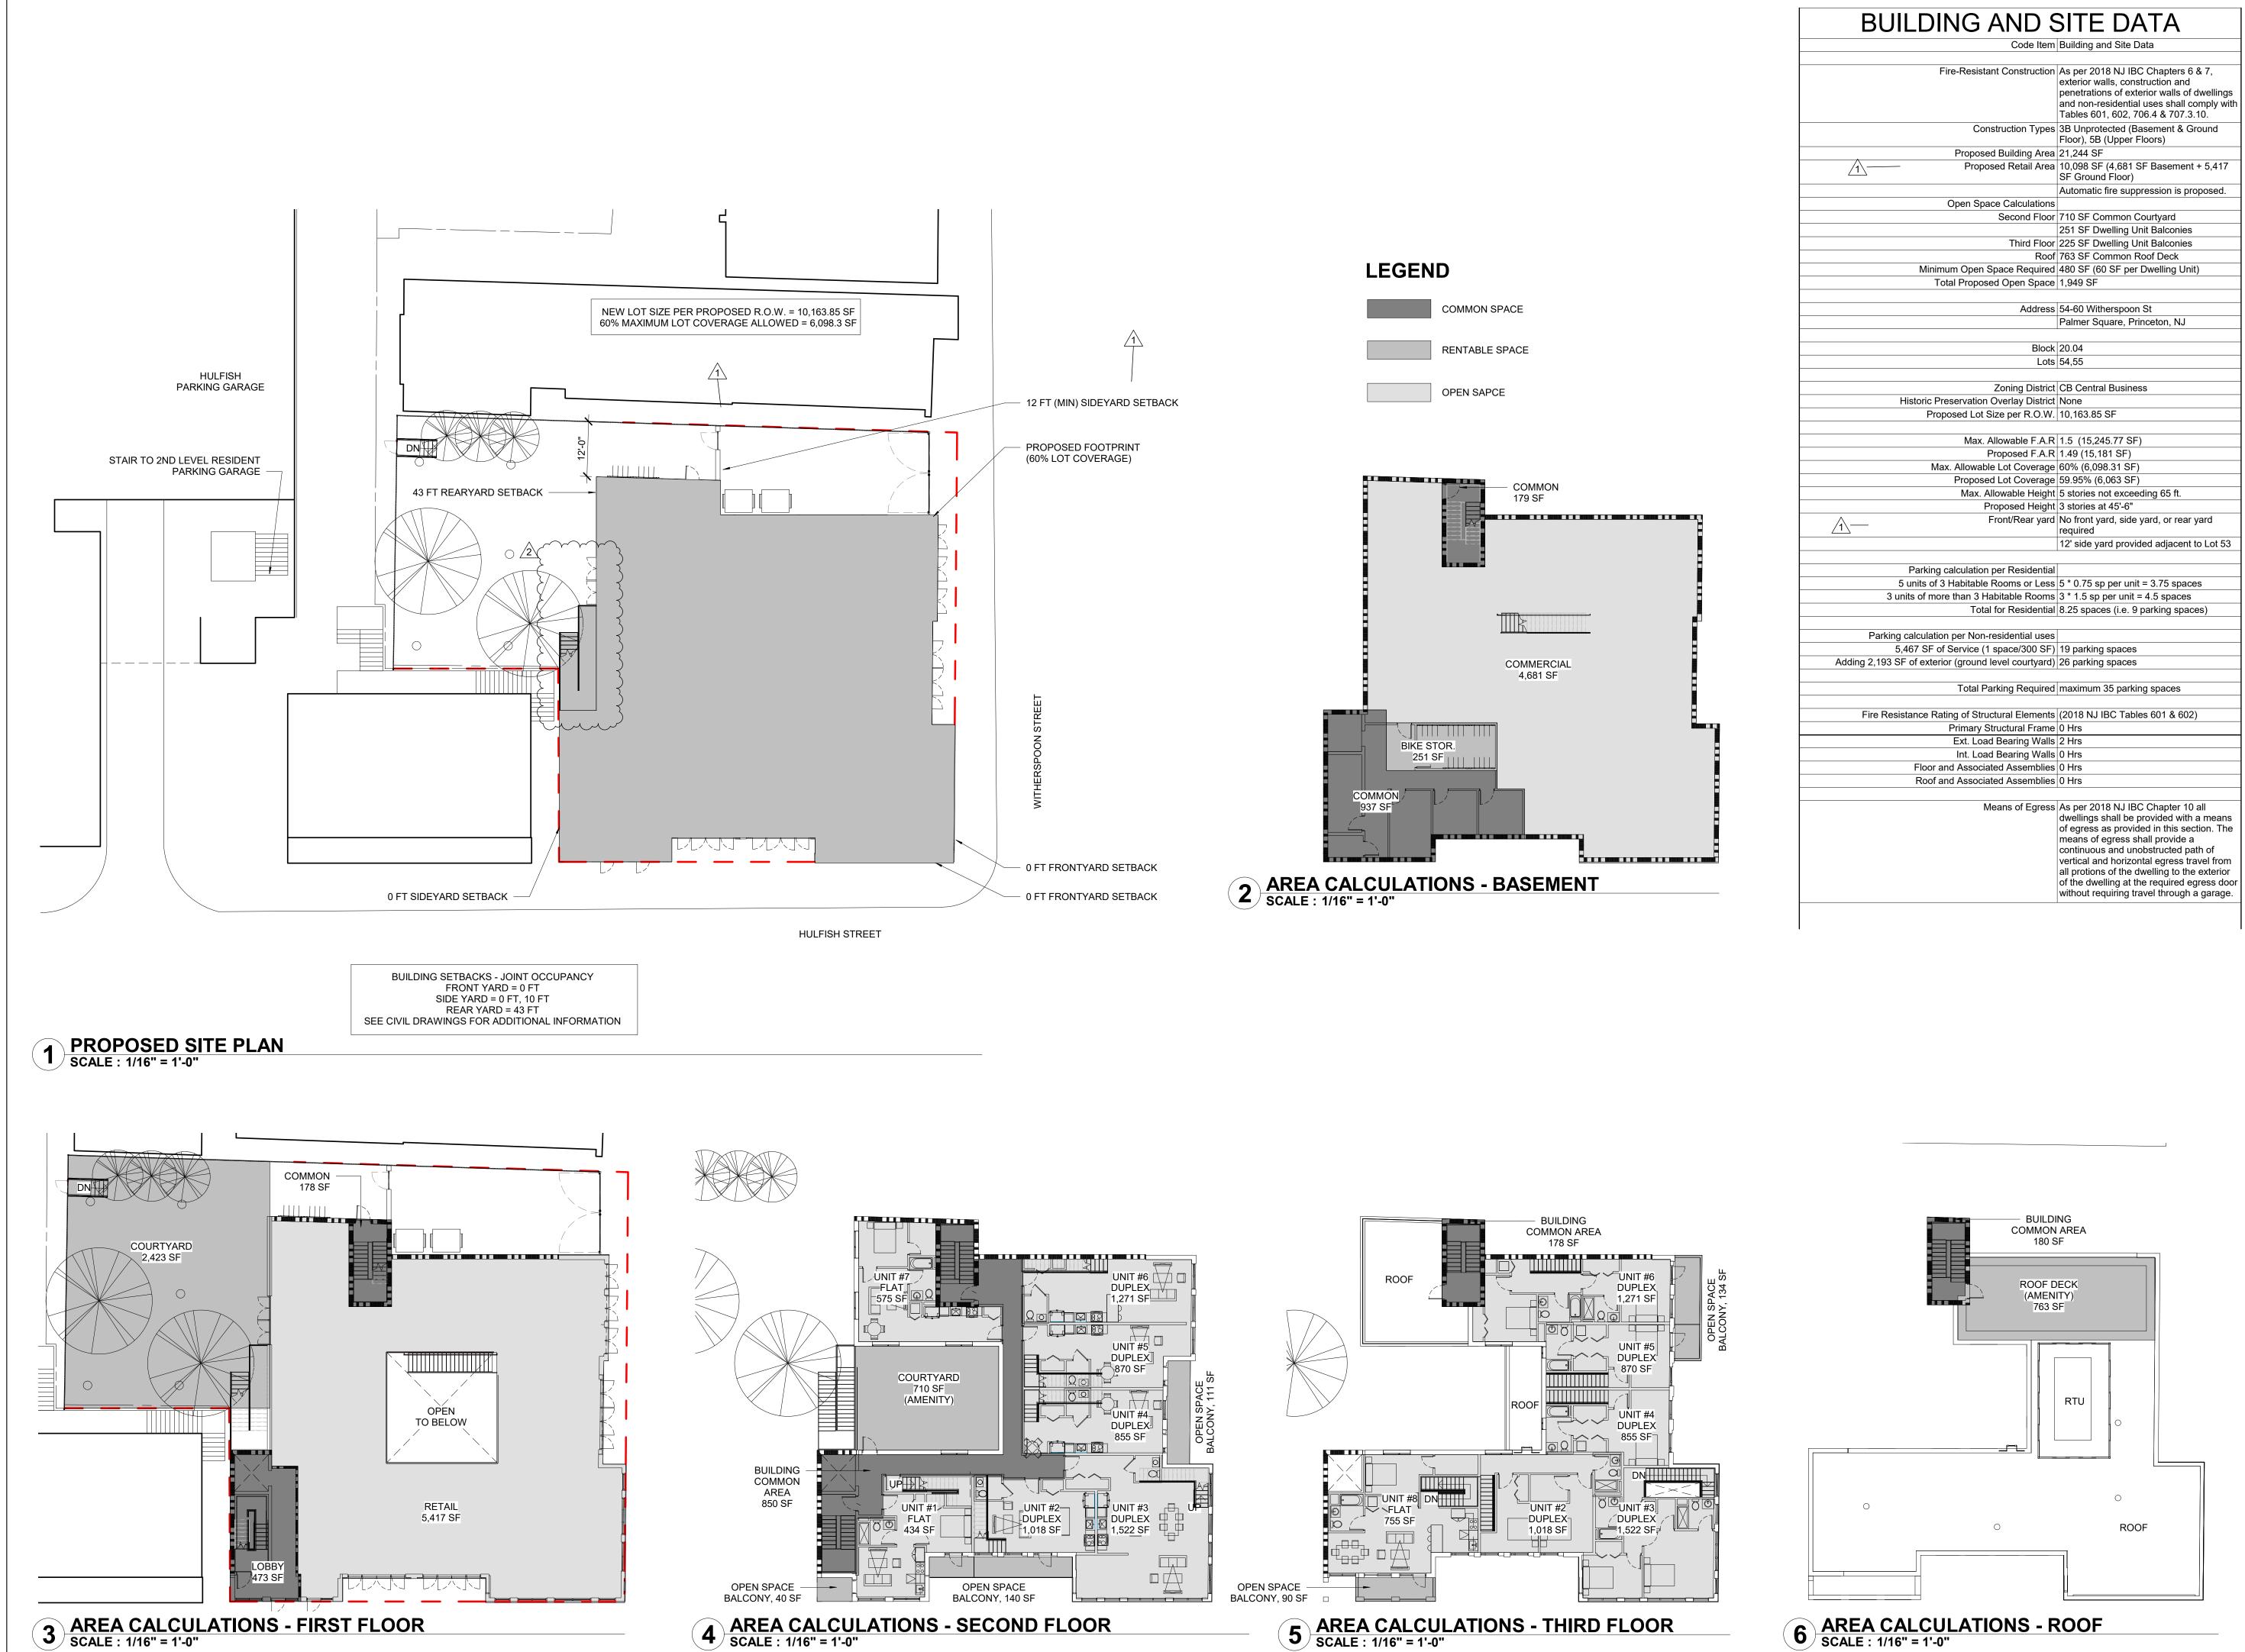

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12-21-2020 MUNICIPAL COMMENTS

12-21-2020 MUNICIPAL COMMENTS / 12-09-2020 MUNICIPAL COMMENTS / 11-09-2020 MUNICIPAL REVIEW

DATE ISSUED FOR

SEAL

STATE OF NEW JERSEY REGISTERED ARCHITECT

JOSHUA B. ZINDER NJ 15316 PROJECT NAME

GRIGG'S CORNER

54-60 WITHERSPOON STREET PRINCETON, NJ 08542


DRAWING NAME

SITE PLANS AND AREA CALCULATIONS

DRAWN BY: JL, MP PROJECT NO.: 21920
DATE: 12-23-2019 SCALE: As indicate

**A0-1** 

SHEET NUMBER

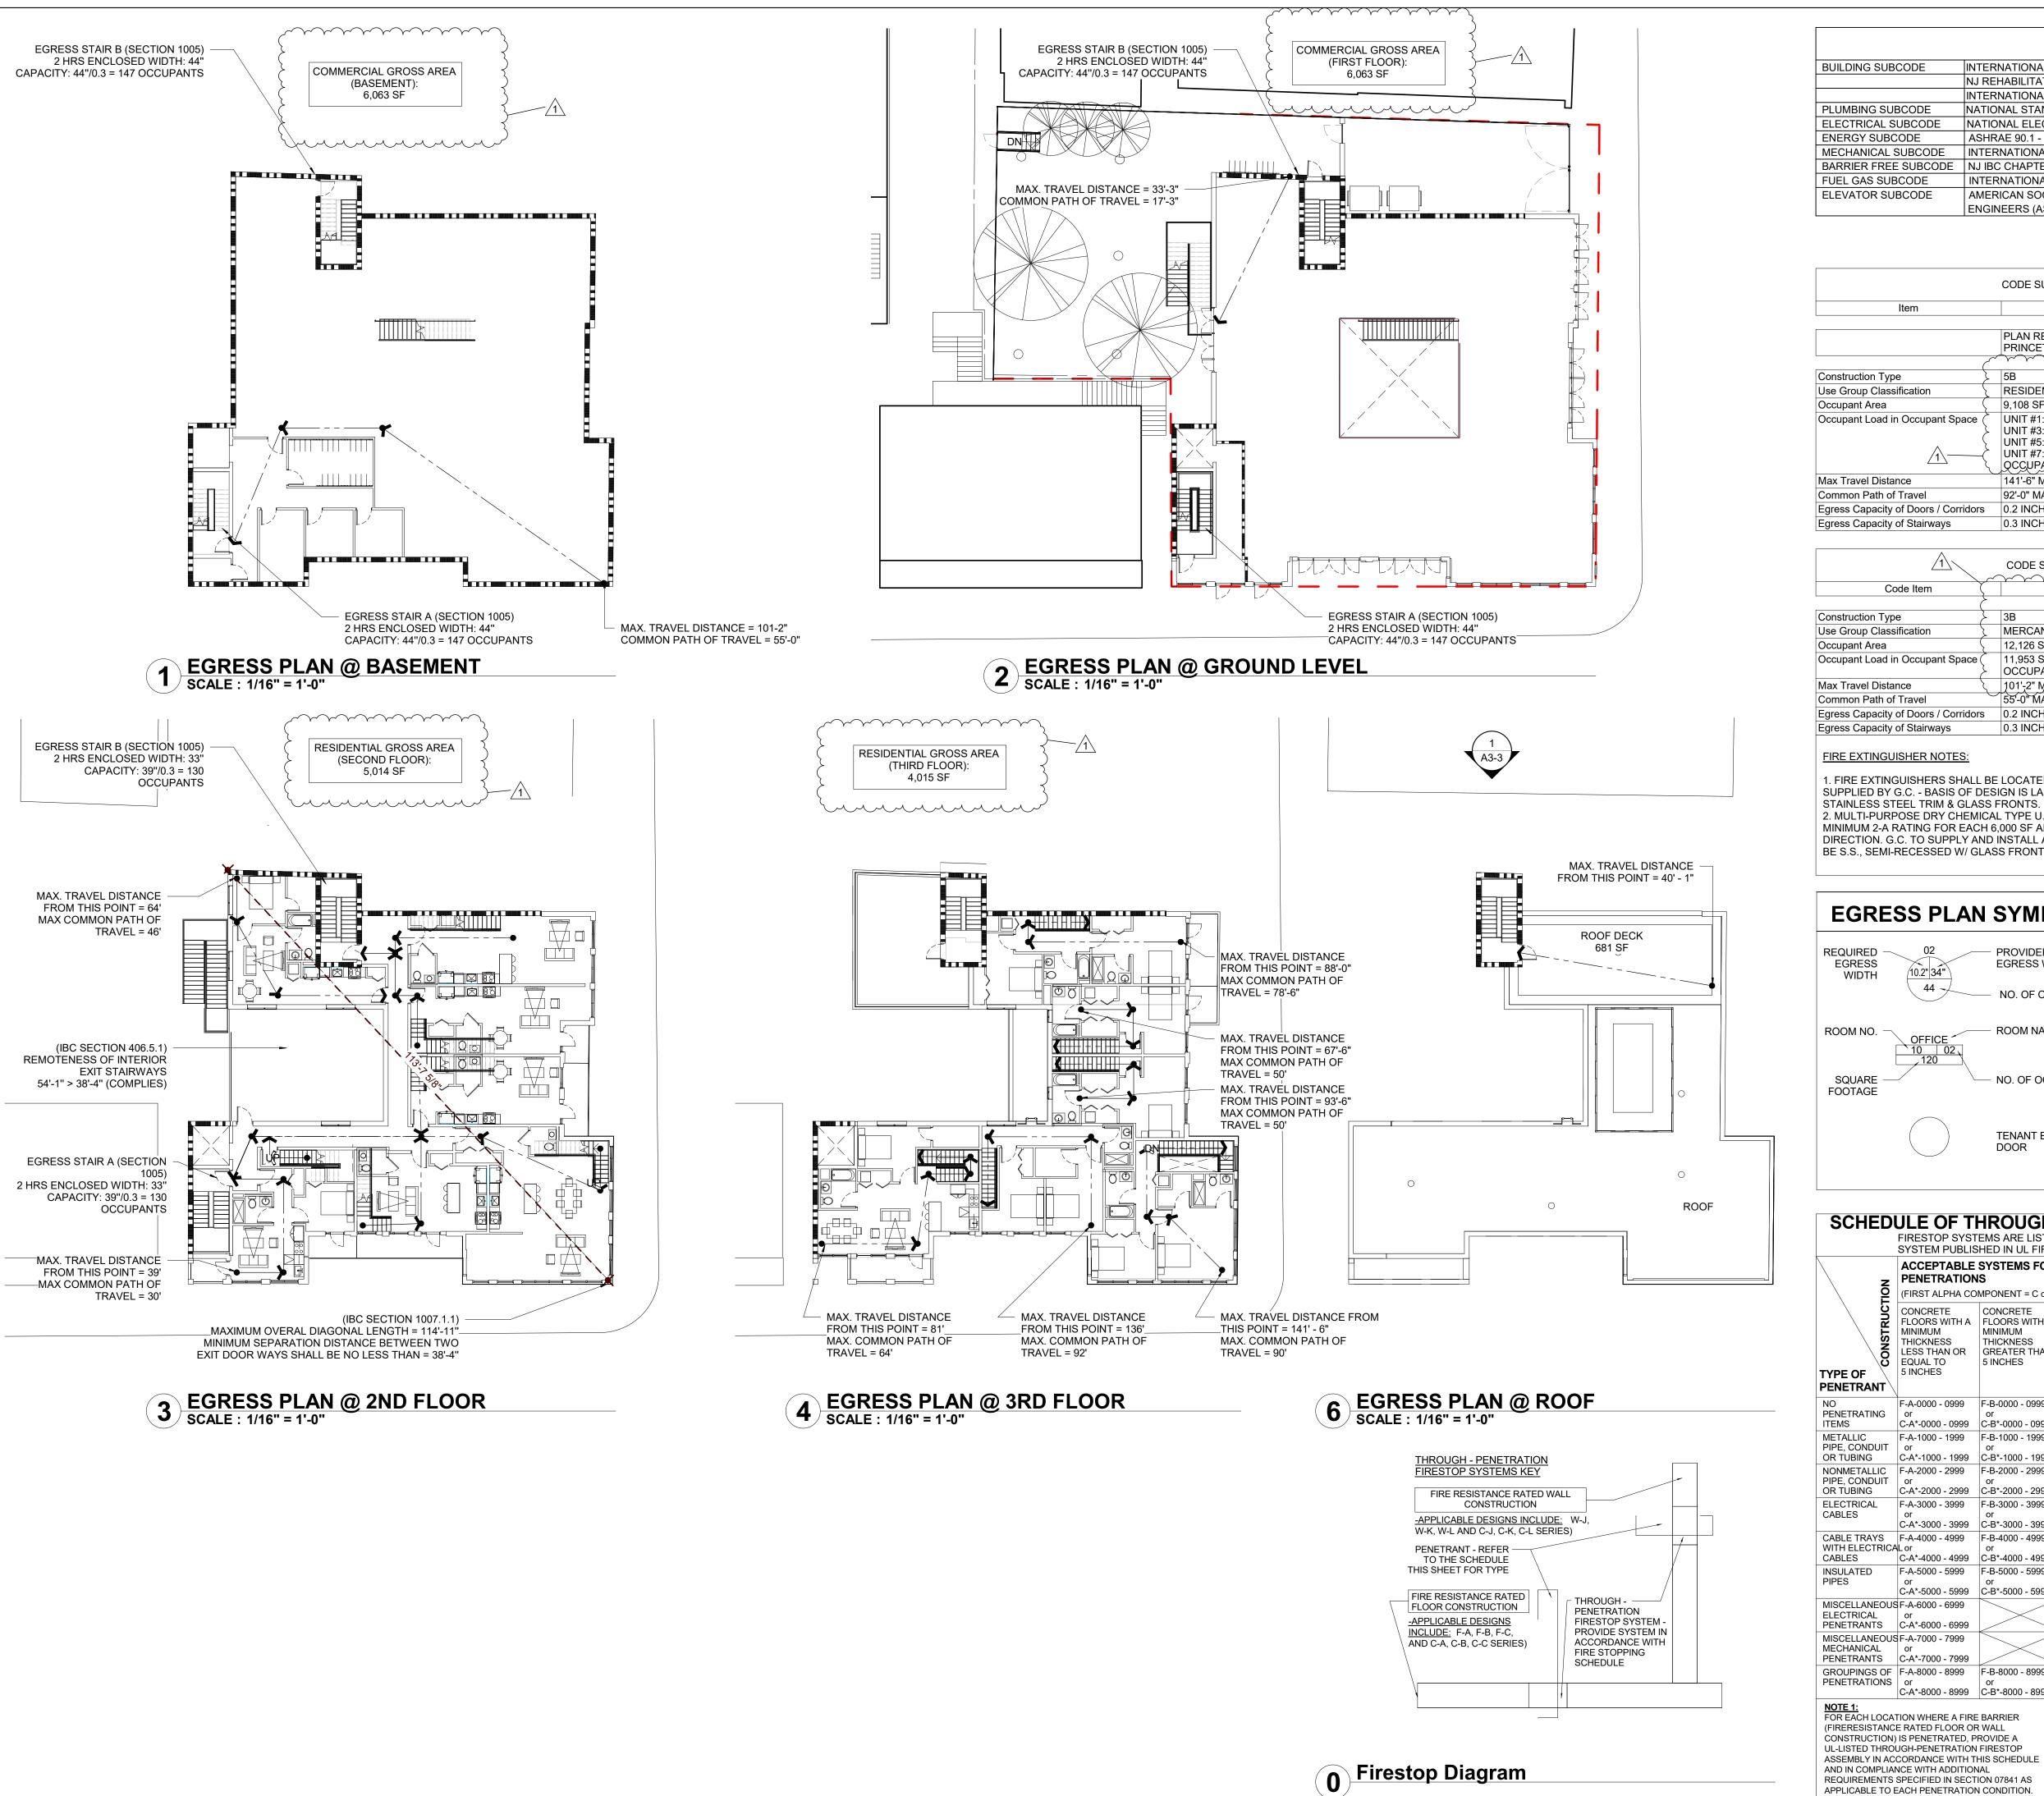

APPLICABLE CODES				
BUILDING SUBCODE	INTERNATIONAL BUILDING CODE 2018 (NJ EDITION)	NJAC 5:23-3.14		
	NJ REHABILITATION SUBCODE NJAC 5:23-6	NJAC 5:32-6.1-5:23-6.32		
	INTERNATIONAL FIRE CODE 2018			
PLUMBING SUBCODE	NATIONAL STANDARD PLUMBING CODE 2018	NJAC 5:23-3.15		
ELECTRICAL SUBCODE	NATIONAL ELECTRICAL CODE (NFPA 70) / 2017	NJAC 5:23-3.16		
ENERGY SUBCODE	ASHRAE 90.1 - 2016	NJAC 5:23-3.18		
MECHANICAL SUBCODE	INTERNATIONAL MECHANICAL CODE 2018	NJAC 5:23-3.20		
BARRIER FREE SUBCODE	NJ IBC CHAPTER 11, NJAC 5:23-7, ICC / ANSI A117.1-2009	NJAC 5:23-7		
FUEL GAS SUBCODE	INTERNATIONAL FUEL GAS CODE 2018	NJAC 5:23-3.22		
ELEVATOR SUBCODE	AMERICAN SOCIETY OF MECHANICAL	NJAC 5:23-12		
	ENGINEERS (ASME)			

	CODE SUMMARY FOR R-2 OCCUPANCY
Item	Project Data
	PLAN REVIEW, PERMITS, AND INSPECTIONS ARE BY THE MUNICIPALITY O PRINCETON.
Construction Type	5B
Use Group Classification	RESIDENTIAL "R-2"
Occupant Area	9,108 SF (UPPER LEVELS)
Occupant Load in Occupant Space	UNIT #1: 434 SF / 200 SF = 2.17 OCC., UNIT #2: 1,018 SF / 200 SF = 5.09 OCC UNIT #3: 1,522 SF / 200 SF = 7.61 OCC., UNIT #4: 855 SF / 200 SF = 4.28 OCC UNIT #5: 870 SF / 200 SF = 4.35 OCC., UNIT #6: 1,271 SF / 200 SF = 6.36 OCC UNIT #7: 588 SF / 200 SF = 2.94 OCC., UNIT #8: 755 SF / 200 SF = 3.78 OCC., OCCUPANCY TOTAL: 9,108 SF / 200 SF = 45.54 OCC.
Max Travel Distance	141'-6" MAX. ACTUAL; 250 FEET ALLOWED (IBC TABLE 1017.2)
Common Path of Travel	92'-0" MAX. ACTUAL; 125 FEET ALLOWED (IBC TABLE 1006.2.1)
Egress Capacity of Doors / Corridors	0.2 INCHES REQUIRED PER OCCUPANT (IBC 1005.3.2)
Egress Capacity of Stairways	0.3 INCHES REQUIRED PER OCCUPANT (IBC 1005.3.1)


	CODE SUMMARY FOR M-OCCUPANCY
$\sim$	
(	Building Info
}	3B
	MERCANTILE "M"
{	12,126 SF (BASEMENT & GROUND LEVEL)
	11,953 SF / 60 SF = 182.6 OCC., STORAGE: 599 SF / 300 SF = 2 OCC., OCCUPANCY TOTAL: 184.6 OCC.
ζ,	101'-2" MAX, ACTUAL; 250 FEET, ALLOWED (IBC, TABLE, 1017.2),
	55'-0" MAX. ACTUAL; 75 FEET ALLOWED (IBC TABLE 1006.2.1)
s	0.2 INCHES REQUIRED PER OCCPUANT (IBC 1005.3.2)
	0.3 INCHES REQUIRED PER OCCUPANT (IBC 1005.3.1)
	}

### **FIRE EXTINGUISHER NOTES:**

1. FIRE EXTINGUISHERS SHALL BE LOCATED IN FIRE RATED SEMI RECESSED FIRE EXTINGUISHER CABINETS SUPPLIED BY G.C. - BASIS OF DESIGN IS LARSEN'S MANUFACTURING ARCHITECTURAL SERIES FS 2409-43 W/ STAINLESS STEEL TRIM & GLASS FRONTS.

2. MULTI-PURPOSE DRY CHEMICAL TYPE U.L. RATED 2A:10:B:C 5# FOR TYPE A,B,C FIRES. PROVIDE A MINIMUM 2-A RATING FOR EACH 6.000 SF AREA AND A TRAVEL DISTANCE OF NOT MORE THAN 75' IN EACH DIRECTION. G.C. TO SUPPLY AND INSTALL AT ALL LOCATIONS INDICATED. FIRE CABINET ENCLOSURES TO BE S.S., SEMI-RECESSED W/ GLASS FRONTS.

### **EGRESS PLAN SYMBOL LEGEND**

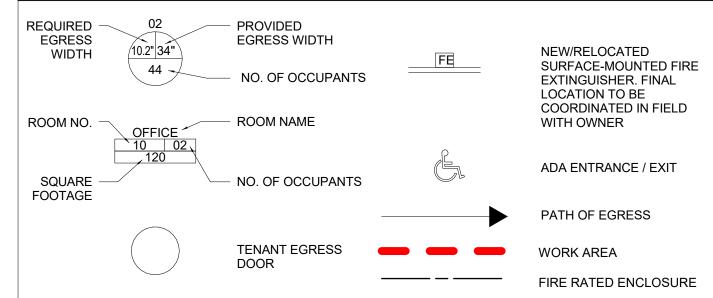

### SCHEDULE OF THROUGH-PENETRATION FIRESTOP SYSTEMS FIRESTOP SYSTEMS ARE LISTED USING THE ALPHA-ALPHA-NUMERICAL IDENTIFICATION

					IE II, CURRENT E		
z	ACCEPTABLE PENETRATION	SYSTEMS FOR	FLOOR	ACCEPTABLE SYSTEMS FOR WALL PENETRATIONS			
(FIRST ALPHA COMPONENT = C or F)			(FIRST ALPHA CO		OMPONENT = C or W)		
TYPE OF CONSTRUCTION	CONCRETE FLOORS WITH A MINIMUM THICKNESS LESS THAN OR EQUAL TO 5 INCHES	CONCRETE FLOORS WITH A MINIMUM THICKNESS GREATER THAN 5 INCHES	FRAMED FLOORS (VARIOUS THICKNESSES)	CONCRETE OR MASONRY WALLS WITH A MINIMUM THICKNESS LESS THAN OR EQUAL TO 8 INCHES	CONCRETE OR MASONRY WALLS WITH A MINIMUM THICKNESS GREATER THAN 8 INCHES	FRAMED WALLS (VARIOUS THICKNESSES)	
NO PENETRATING ITEMS	F-A-0000 - 0999 or C-A*-0000 - 0999	F-B-0000 - 0999 or C-B*-0000 - 0999		W-J-0000 - 0999 or C-*J-0000 - 0999		W-L-0000 - 0999 or C-*L-0000 - 0999	
METALLIC PIPE, CONDUIT OR TUBING	F-A-1000 - 1999 or C-A*-1000 - 1999	F-B-1000 - 1999 or C-B*-1000 - 1999	F-C-1000 - 1999 or C-C*-1000 - 1999	W-J-1000 - 1999 or C-*J-1000 - 1999	W-K-1000 - 1999 or C-*K-1000 - 1999	W-L-1000 - 1999 or C-*L-1000 - 1999	
NONMETALLIC PIPE, CONDUIT OR TUBING	F-A-2000 - 2999 or C-A*-2000 - 2999	F-B-2000 - 2999 or C-B*-2000 - 2999	F-C-2000 - 2999 or C-C*-2000 - 2999	W-J-2000 - 2999 or C-*J-2000 - 2999		W-L-2000 - 2999 or C-*L-2000 - 2999	
ELECTRICAL CABLES	F-A-3000 - 3999 or C-A*-3000 - 3999	F-B-3000 - 3999 or C-B*-3000 - 3999	F-C-3000 - 3999 or C-C*-3000 - 3999	W-J-3000 - 3999 or C-*J-3000 - 3999		W-L-3000 - 3999 or C-*L-3000 - 3999	
CABLE TRAYS WITH ELECTRICA CABLES	F-A-4000 - 4999 L or C-A*-4000 - 4999	F-B-4000 - 4999 or C-B*-4000 - 4999		W-J-4000 - 4999 or C-*J-4000 - 4999	W-K-4000 - 4999 or C-*K-4000 - 4999	W-L-4000 - 4999 or C-*L-4000 - 4999	
INSULATED PIPES	F-A-5000 - 5999 or C-A*-5000 - 5999	F-B-5000 - 5999 or C-B*-5000 - 5999	F-C-5000 - 5999 or C-C*-5000 - 5999	W-J-5000 - 5999 or C-*J-5000 - 5999		W-L-5000 - 5999 or C-*L-5000 - 5999	
MISCELLANEOUS ELECTRICAL PENETRANTS	F-A-6000 - 6999 or C-A*-6000 - 6999			W-J-6000 - 6999 or C-*J-6000 - 6999		W-L-6000 - 6999 or C-*L-6000 - 6999	
MISCELLANEOUS MECHANICAL PENETRANTS	F-A-7000 - 7999 or C-A*-7000 - 7999		F-C-7000 - 7999 or C-C*-7000 - 7999	W-J-7000 - 7999 or C-*J-7000 - 7999		W-L-7000 - 7999 or C-*L-7000 - 7999	
GROUPINGS OF PENETRATIONS	F-A-8000 - 8999 or C-A*-8000 - 8999	F-B-8000 - 8999 or C-B*-8000 - 8999	F-C-8000 - 8999 or C-C*-8000 - 8999	W-J-8000 - 8999 or C-*J-8000 - 8999		W-L-8000 - 8999 or C-*L-8000 - 8999	
(FIRERESISTANC CONSTRUCTION) UL-LISTED THROU ASSEMBLY IN ACC AND IN COMPLIAN	TION WHERE A FIRE E RATED FLOOR OF IS PENETRATED, PUGH-PENETRATION CORDANCE WITH TO THE WITH ADDITION SPECIFIED IN SECT	R WALL ROVIDE A FIRESTOP HIS SCHEDULE IAL	NOTE 2: ACTUAL UL LIS C- SERIES SYS CONTAIN AN A ALPHA CHARA IDENTIFIED BY ASTERISK ON SCHEDULE	STEMS DDITIONAL CTER 'AN	NUMBERING S MAIN FIRE BARRIEF IDENTIFICATION  C-A*-0 SECONDARY FIRE BARRIER IDENTIFICATION(S) PENETRANT	001	

APPLICABLE TO EACH PENETRATION CONDITION.

PENETRANT IDENTIFICATION —

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## **GRIGG'S** CORNER

STATE OF NEW JERSEY REGISTERED ARCHITECT

JOSHUA B. ZINDER

NJ 15316

PROJECT NAME


54-60 WITHERSPOON STREET PRINCETON, NJ 08542

DRAWING NAME

**LIFE SAFETY PLANS & CODE** INFO

JL, MP PROJECT NO.: 21920 12-23-2019 SCALE: SHEET NUMBER

**A0-2** 

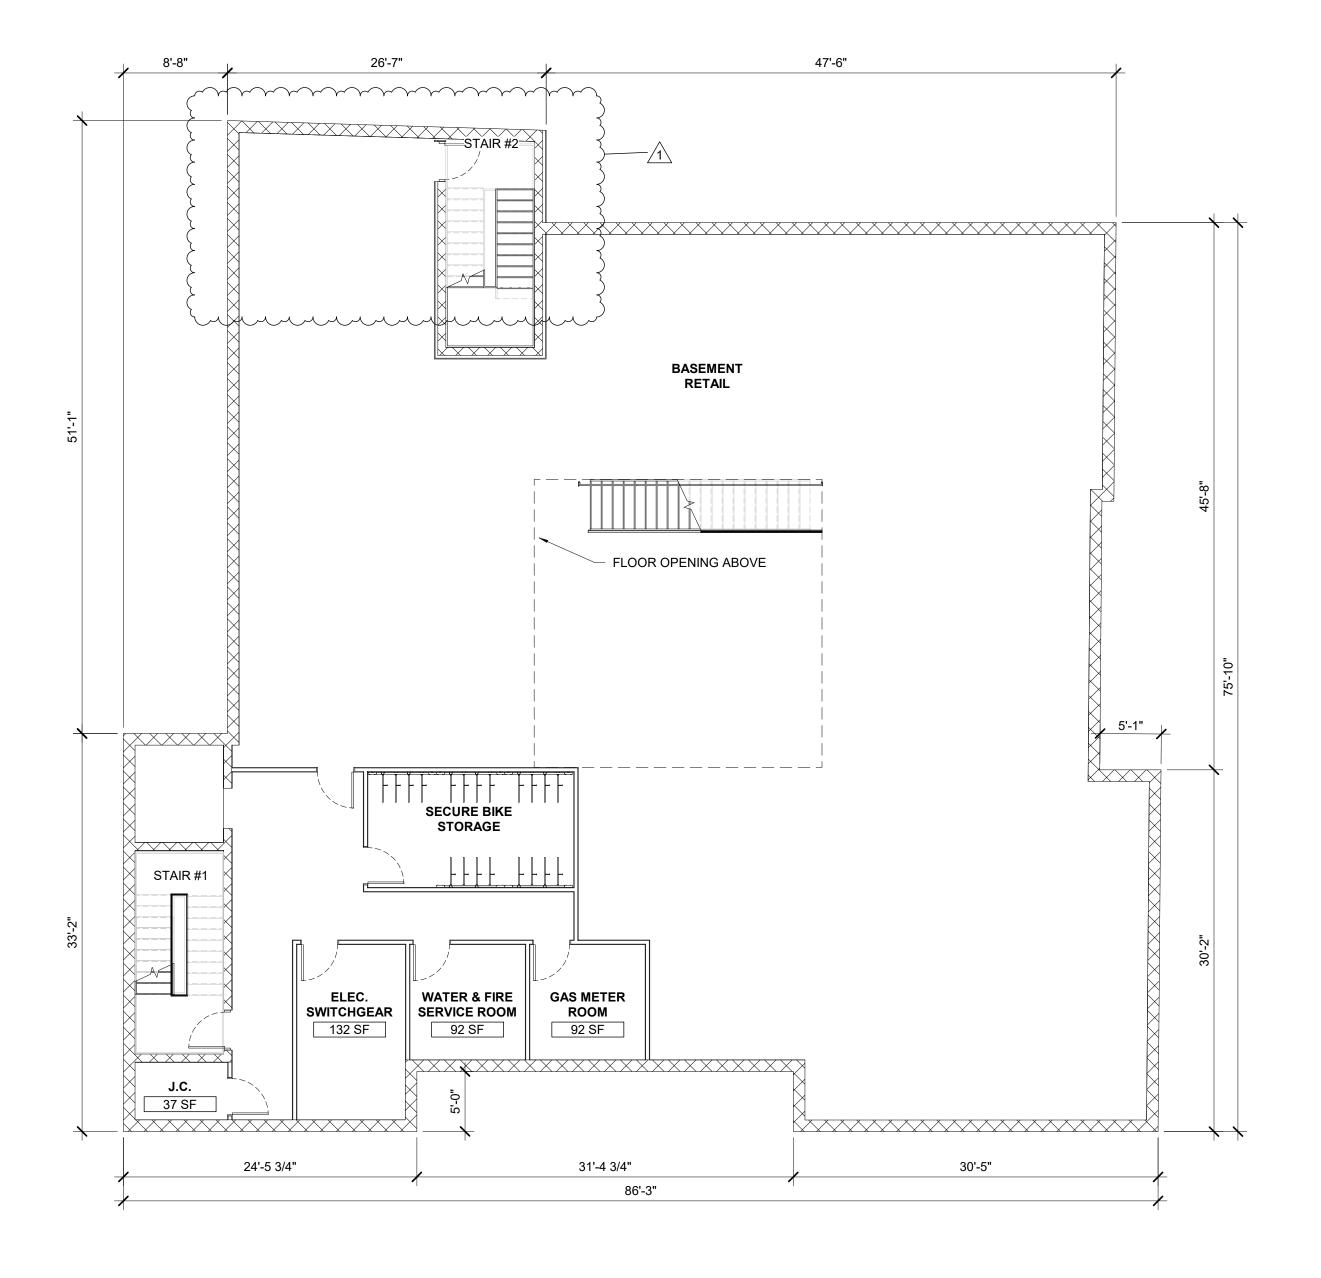

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PROJECT NAME

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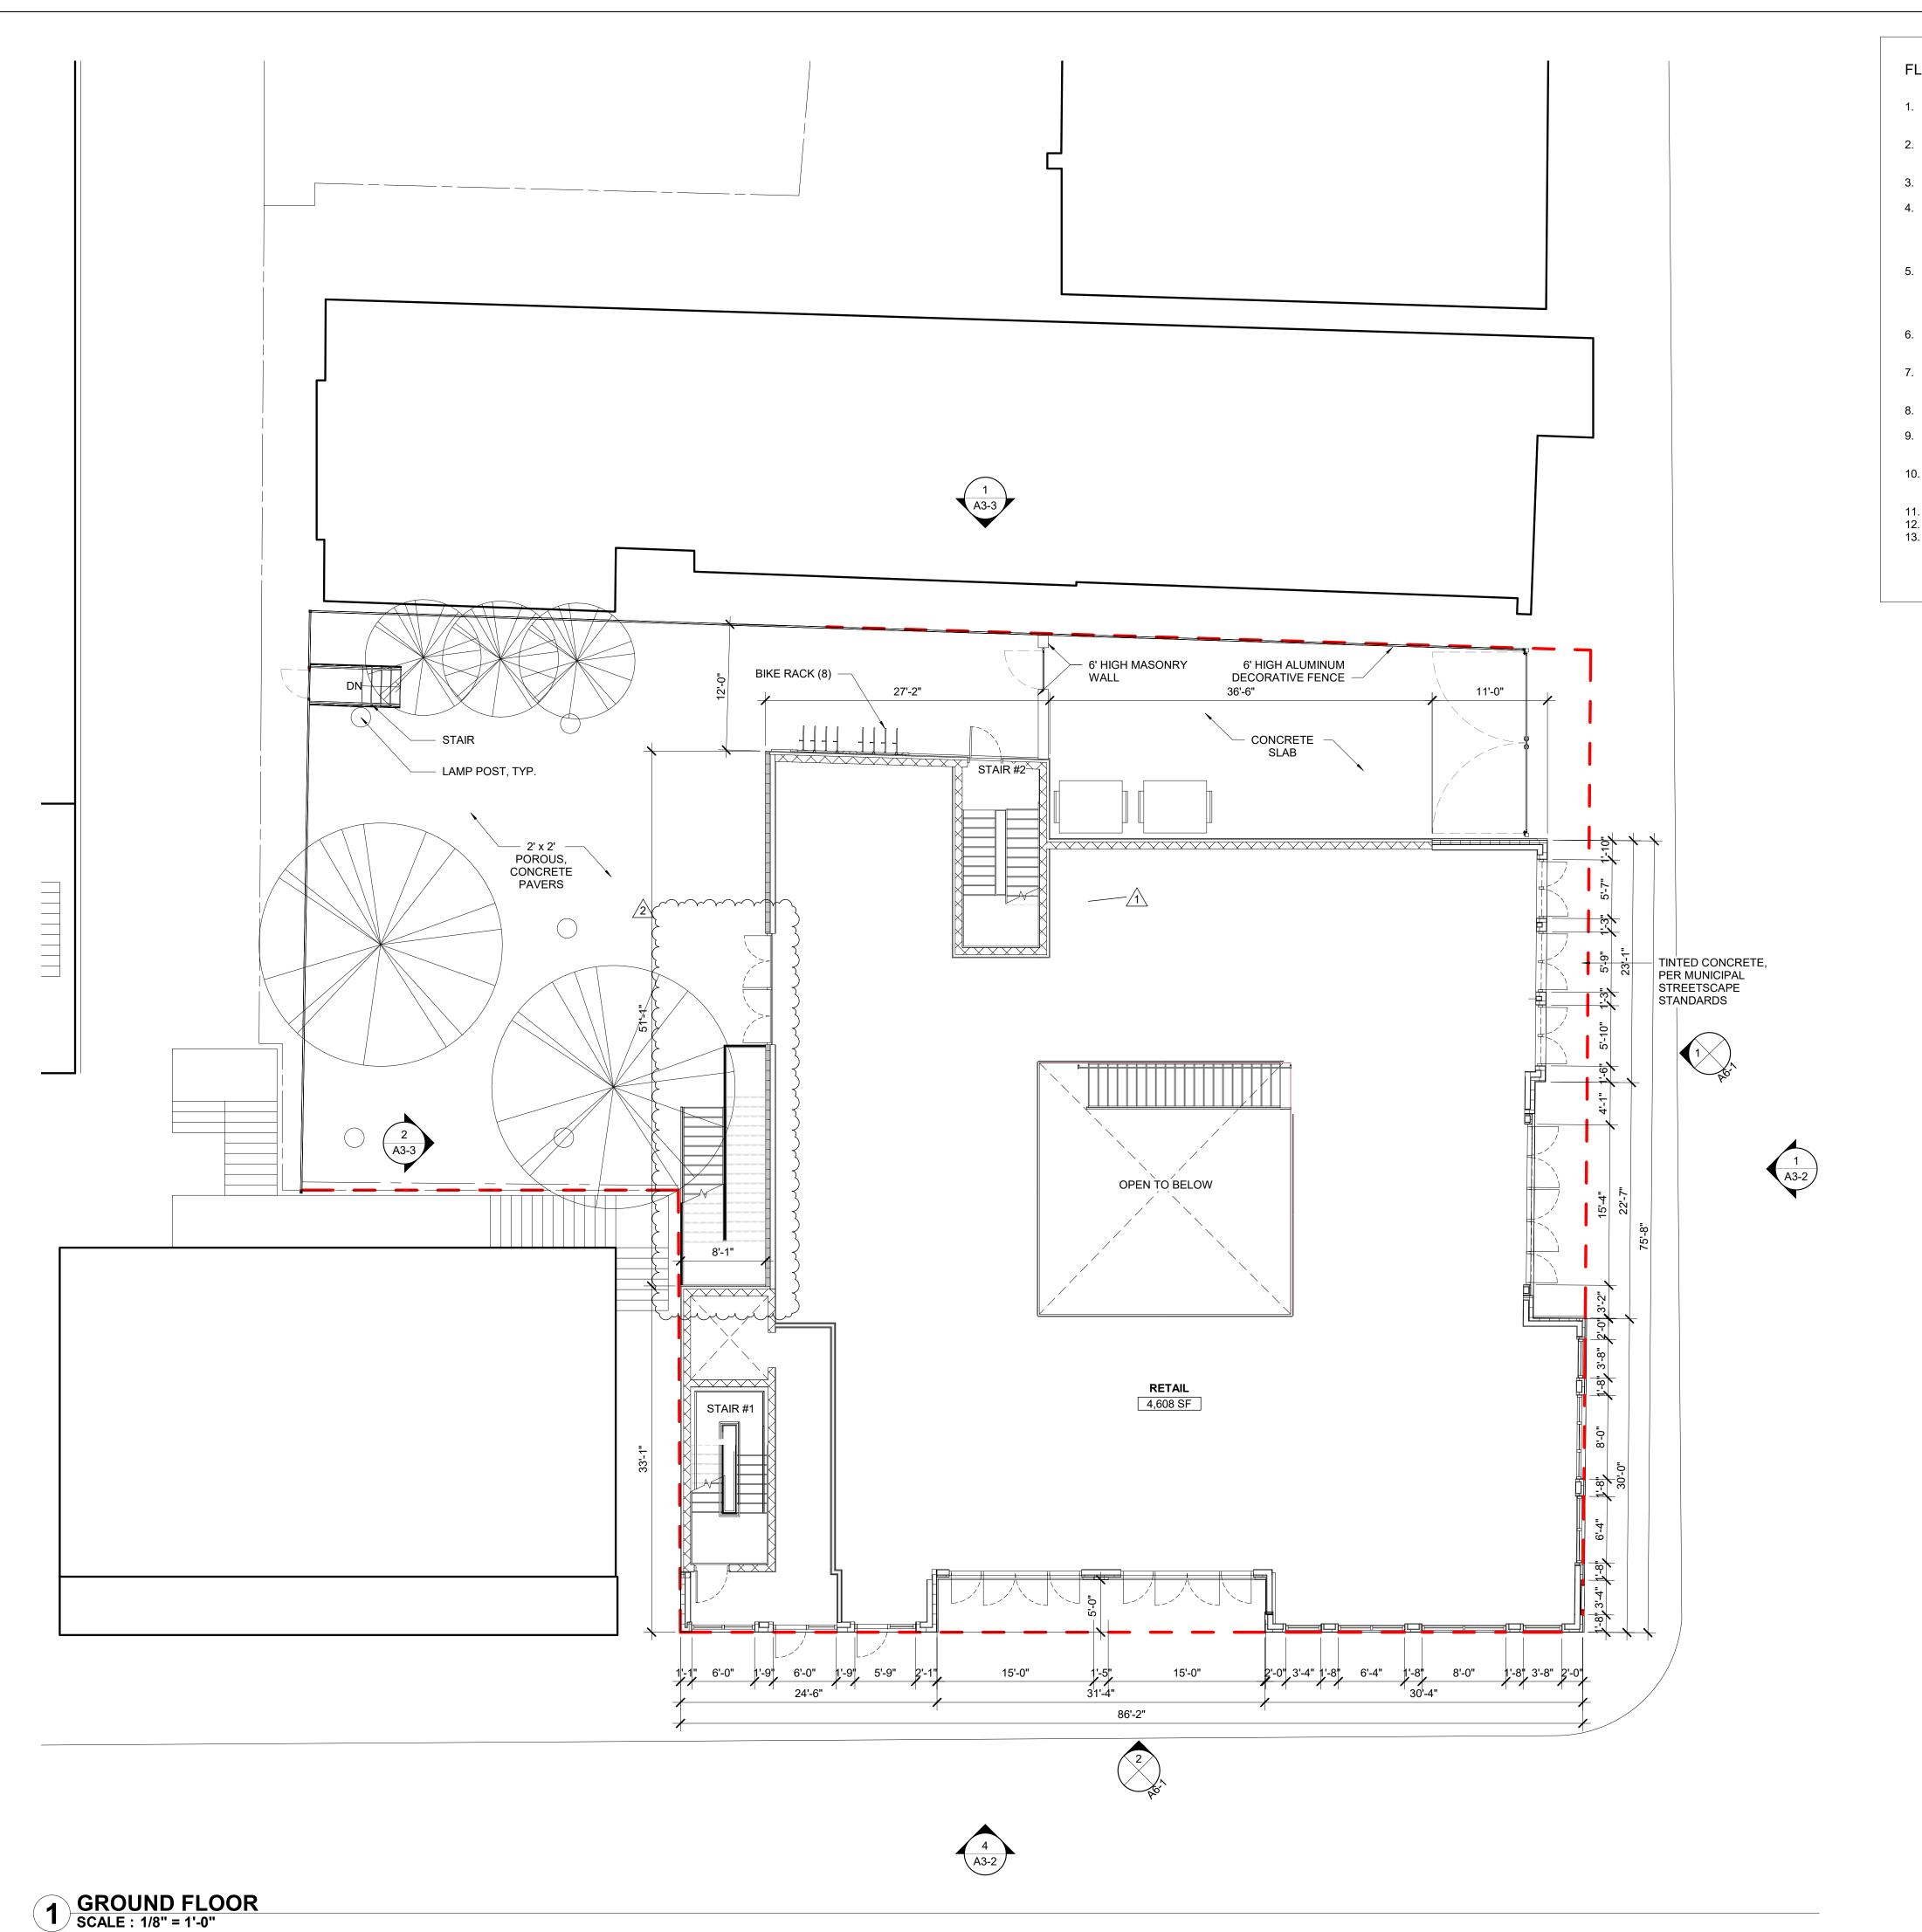
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DRAWING NAME

**BASEMENT PLAN** 

DRAWN BY: JL, MP

PROJECT NO.: 21920 12-23-2019 SCALE: As indicated SHEET NUMBER



#### FLOOR PLAN GENERAL NOTES

- 1. DRAWINGS ARE NOT TO BE SCALED, WRITTEN PREVAIL. IF QUESTIONS REGARDING A DIMENSIONAL DISCOVERY ARISE, A CLARIFICATION FROM THE ARCHITECT PRIOR TO CONTINUING WITH THE CONSTRUCTION IS THE RESPONSIBILITY OF THE GENERAL CONTRACTOR.
- THE CONTRACTOR SHALL BE RESPONSIBLE FOR VERIFYING THE EXISTING CONDITIONS PRIOR TO BIDDING AND SHALL BE FAMILIAR WITH ALL ASPECTS OF THE JOB, ALL DIMENSIONS, AND CONDITIONS AT THE JOB SITE PRIOR TO THE START OF ANY WORK.
- ITEMS MARKED "N.I.C." (NOT IN CONTRACT) ARE NOT INCLUDED IN THE GENERAL CONTRACTOR'S CONTRACT AND SHALL BE PROVIDED BY THE OWNER.
- PIPING LOCATED ABOVE GRADE AND INSIDE THE BUILDING SHALL BE CONCEALED IN FURRED SPACE WITH THE EXCEPTION OF PIPING IN STAIRWAYS, EQUIPMENT ROOMS, AND IF SPECIFICALLY DESIGNATED ON THE DRAWINGS. THE CONTRACTOR SHALL COORDINATE WITH OTHER TRADES TO PROVIDE FURRING FOR PIPING INSTALLED IN FINISHED AREAS. IF 'FURRED SPACES' ARE NOT
- SPECIFICALLY DESIGNATED ON THE DRAWINGS, CONTRACTOR TO CONTACT ARCHITECT. FOR ALL RATED AND/OR SMOKE PARTITIONS, THE SURFACE AREA OF AN INDIVIDUAL RECESSED METALLIC OUTLET, SWITCH BOX, ETC. SHALL NOT EXCEED 16 SQUARE INCHES. THE AGGREGATE SURFACE AREA OF RECESSED OUTLET BOXES, ETC. SHALL NOT EXCEED 100 SQUARE INCHES PER 100 SQUARE FEET OF WALL AREA OR AS PER APPLICABLE CODE. CONTRACTOR TO VERIFY THIS
- ALL RATED PARTITIONS SHALL BE TIGHTLY SEALED TO THE UNDERSIDE OF THE STRUCTURAL DECK. INTEGRITY OF PARTITIONS SHALL BE MAINTAINED AT CORNERS AND AT INTERSECTIONS OF
- PENETRATION IN RATED PARTITIONS FOR CONDUIT, PIPING, OR OTHER COMBUSTIBLE ITEMS SHALL BE FILLED WITH AN APPROVED NON-COMBUSTIBLE MATERIAL TO PROVIDE AN APPROVED SEAL TO PROHIBIT THE PASSAGE OF FIRE AND SMOKE.
- PROVIDE METAL STUD FRAMING AROUND ALL PENETRATIONS THROUGH METAL STUD/GYPSUM BOARD WALLS.
- CAULK AT JUNCTURE OF INTERIOR FACES OF DOOR FRAMES, VIEW WINDOW FRAMES, EXTERIOR WINDOW FRAMES, CABINET WORK, RECESSED TOILET ACCESSORIES, ETC. WITH ADJACENT MATERIALS EVEN IF THROUGH JOINT MAY NOT BE VISIBLE.
- PROVIDE WOOD BLOCKING AS REQUIRED FOR WALL MOUNTED EQUIPMENT OR ACCESSORIES. NAILERS, BLOCKING, AND OTHER ROUGH CARPENTRY ITEMS IN RATED ASSEMBLIES SHALL BE TREATED FOR FIRE RESISTANCE.
- ALL CASEWORK DIMENSIONS SHALL BE FIELD VERIFIED PRIOR TO FABRICATION. PROVIDE SMOKE/CO DETECTORS IN COMMERCIAL SPACES, ALL UNITS, AND COMMON SPACES.
- DIMENSIONS ARE TAKEN TO FINISH FACE OF PARTITION, U.O.N. DIMENSIONS AT EXTERIOR WALLS ARE TO FINISH FACE, FACE OF MASONRY OR CONCRETE, EDGE OF WALK OR FACE OF CURB, U.O.N. FOR FURTHER DIMENSIONING, SEE LARGE SCALE PLANS AND SECTIONS, ELEVATIONS, AND DETAILS.

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**GRIGG'S** 

54-60 WITHERSPOON STREET PRINCETON, NJ 08542

CORNER

DRAWING NAME

**GROUND FLOOR PLAN** 

12-23-2019

SHEET NUMBER

**A1-1** 



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> **GRIGG'S** CORNER

> 54-60 WITHERSPOON STREET PRINCETON, NJ 08542

DRAWING NAME


SECOND FLOOR **PLAN** 

DRAWN BY: JL, MP

PROJECT NO.: 21920 12-23-2019 SCALE: SHEET NUMBER

**A1-2** 



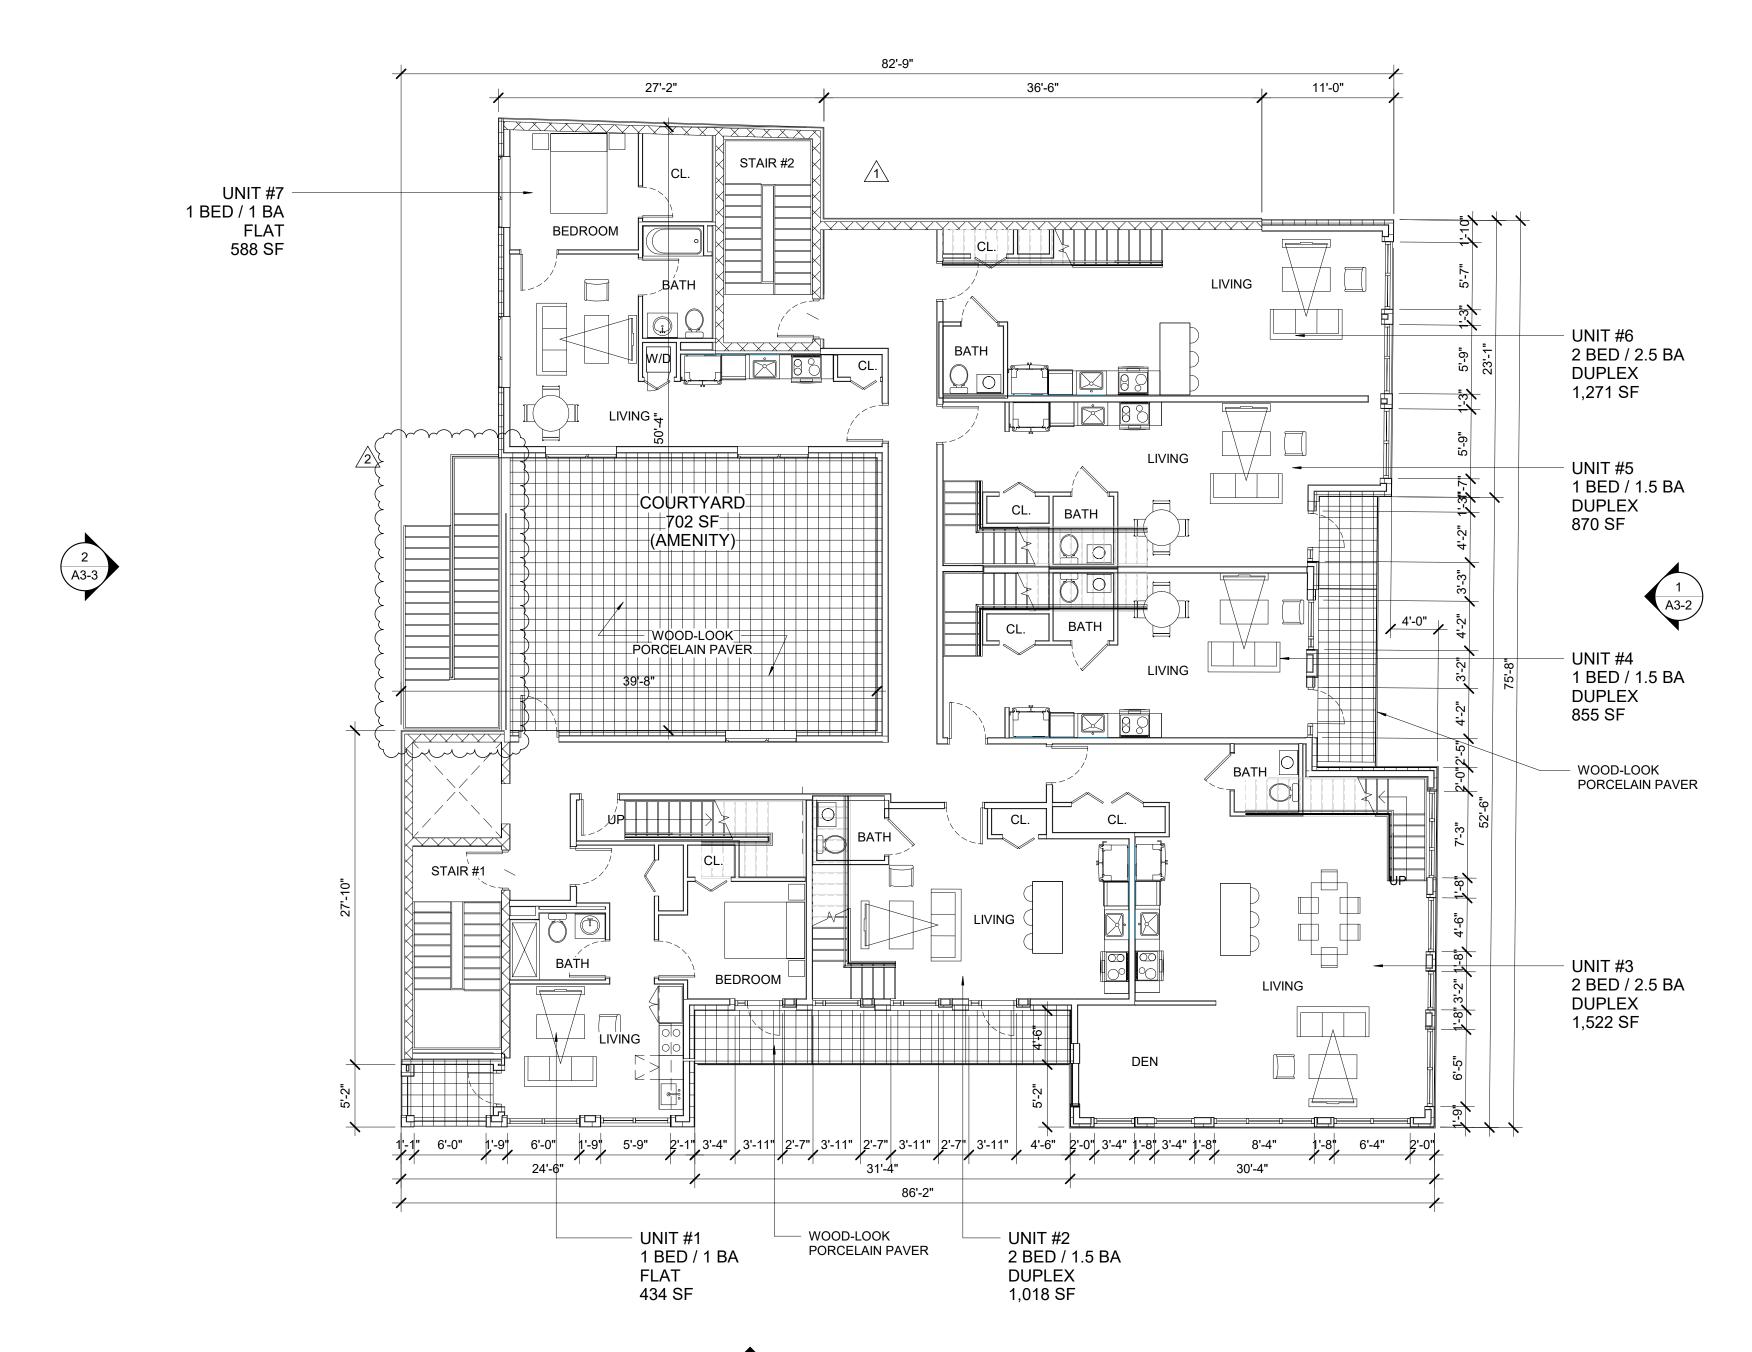





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DRAWING NAME

### THIRD FLOOR PLAN

DRAWN BY: JL, MP

DATE: 12-23-2019


JL, MP PROJECT NO.: 21920

12-23-2019 SCALE: As indicated

SHEET NUMBER


**A1-3** 




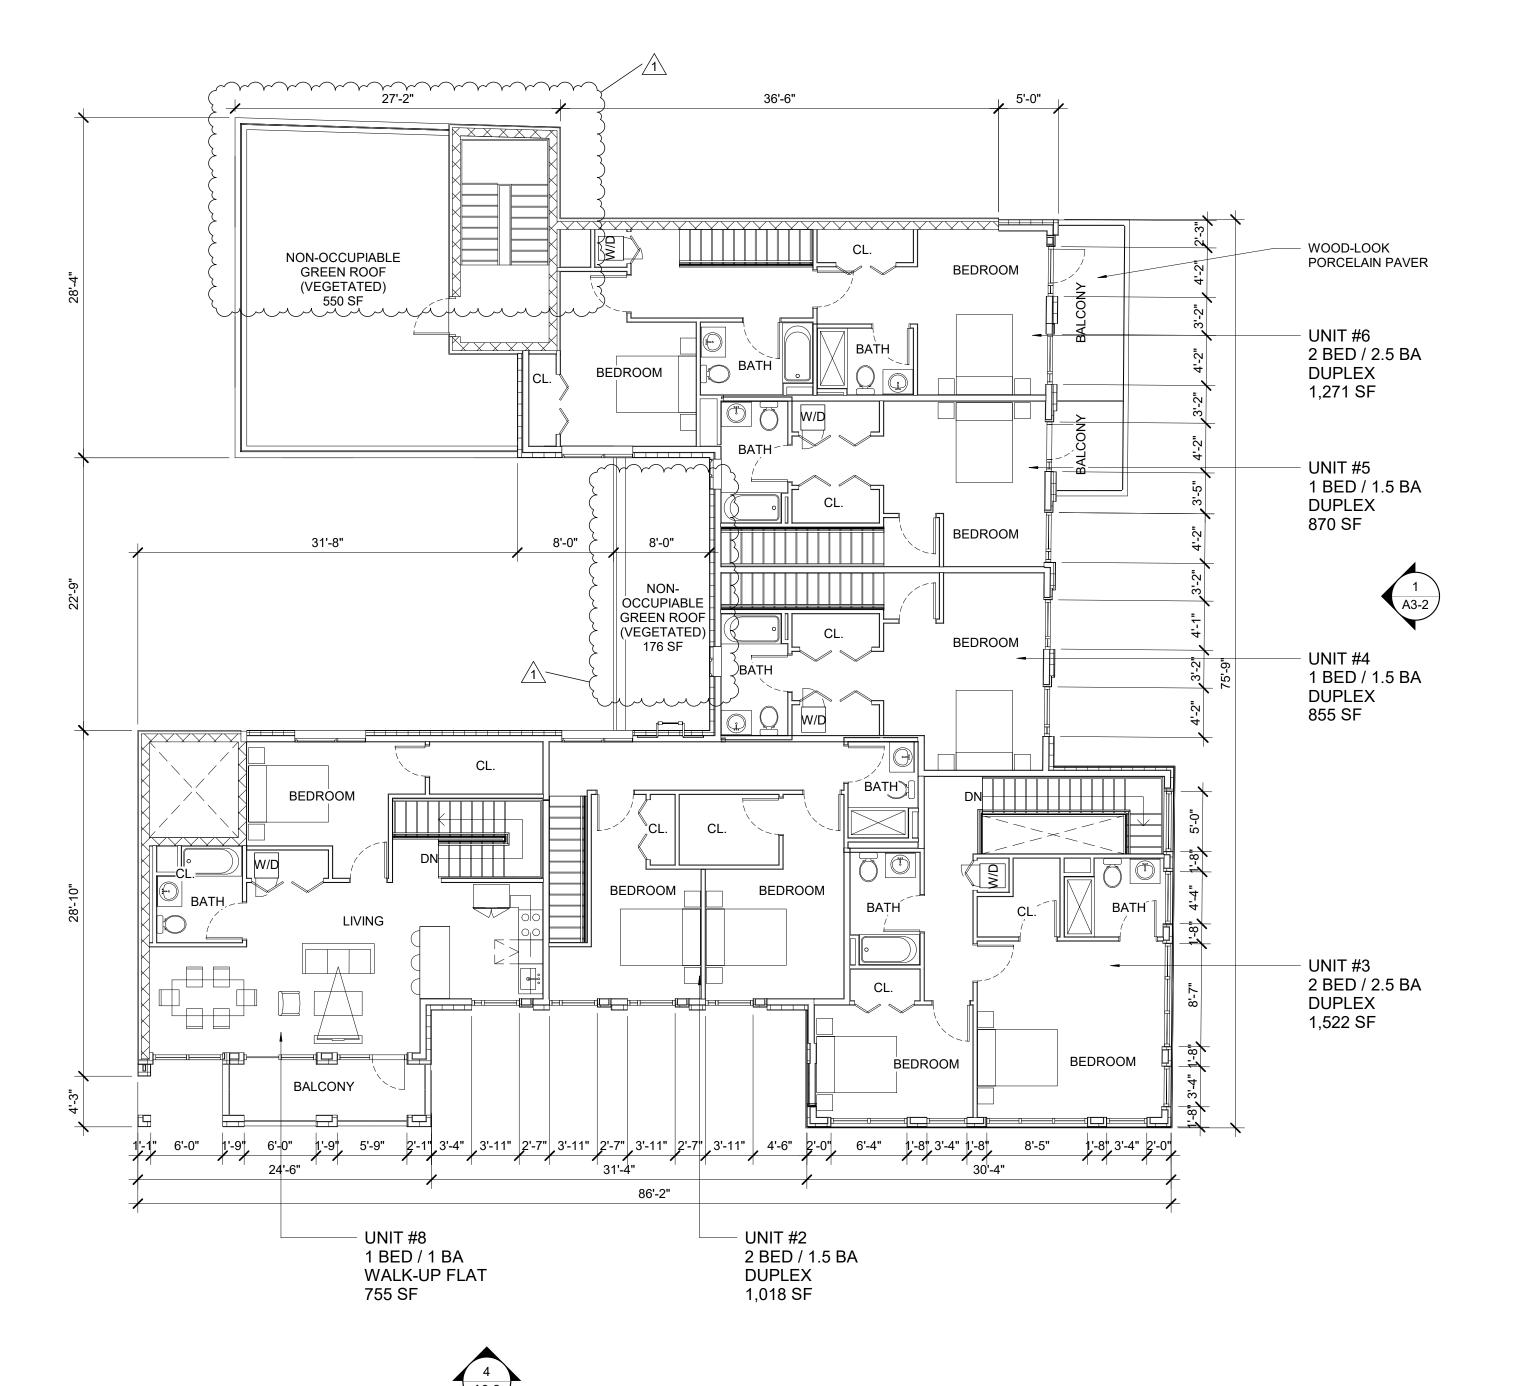



2 A3-3

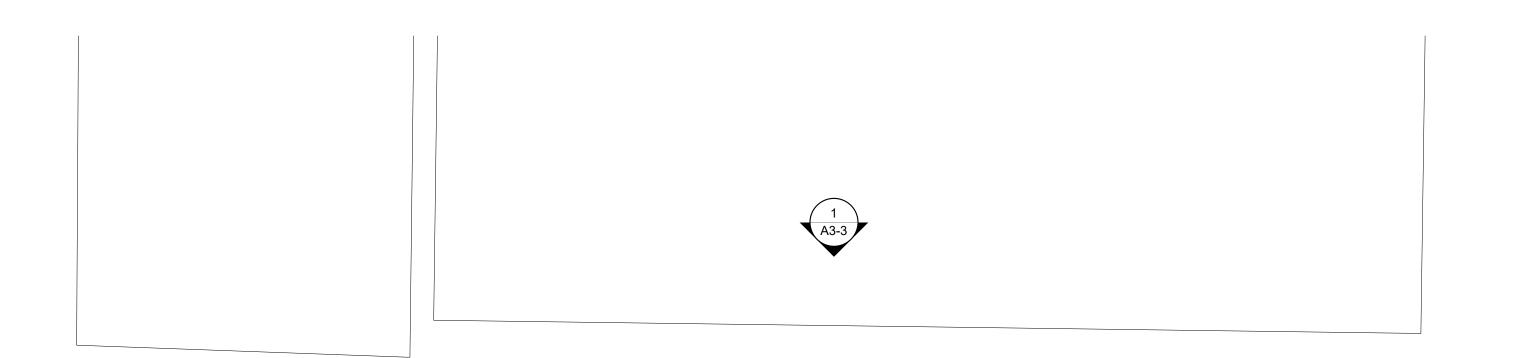

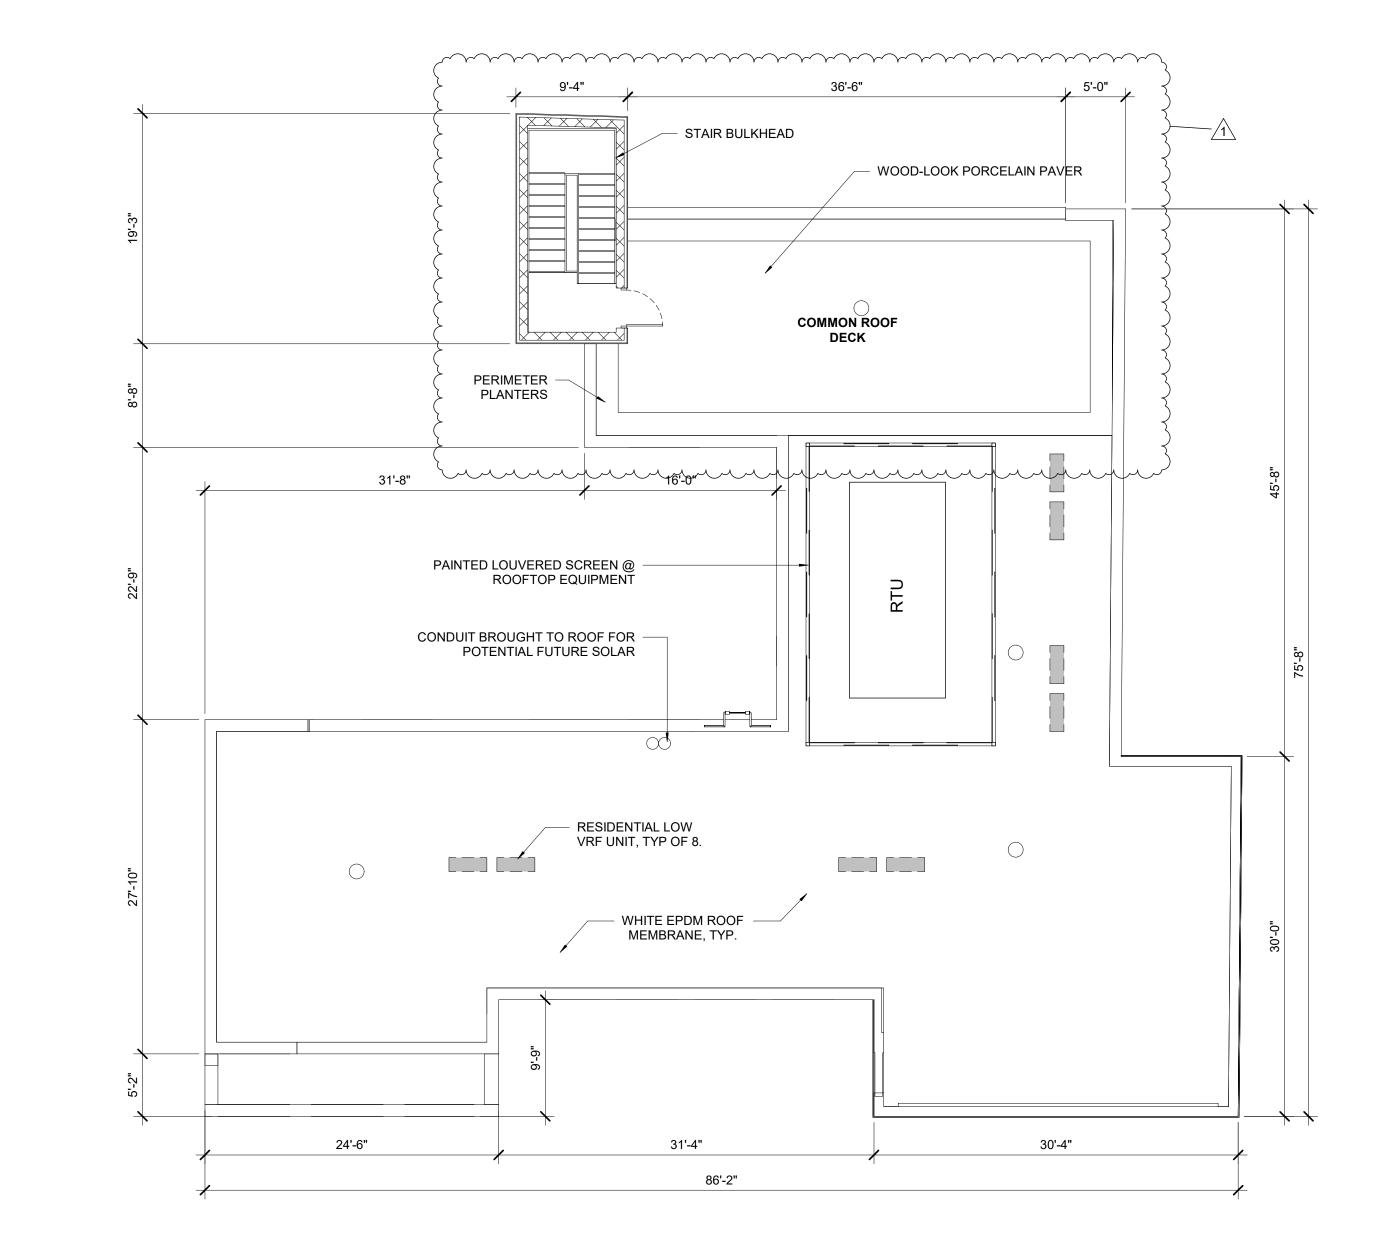



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54-60 WITHERSPOON STREET PRINCETON, NJ 08542

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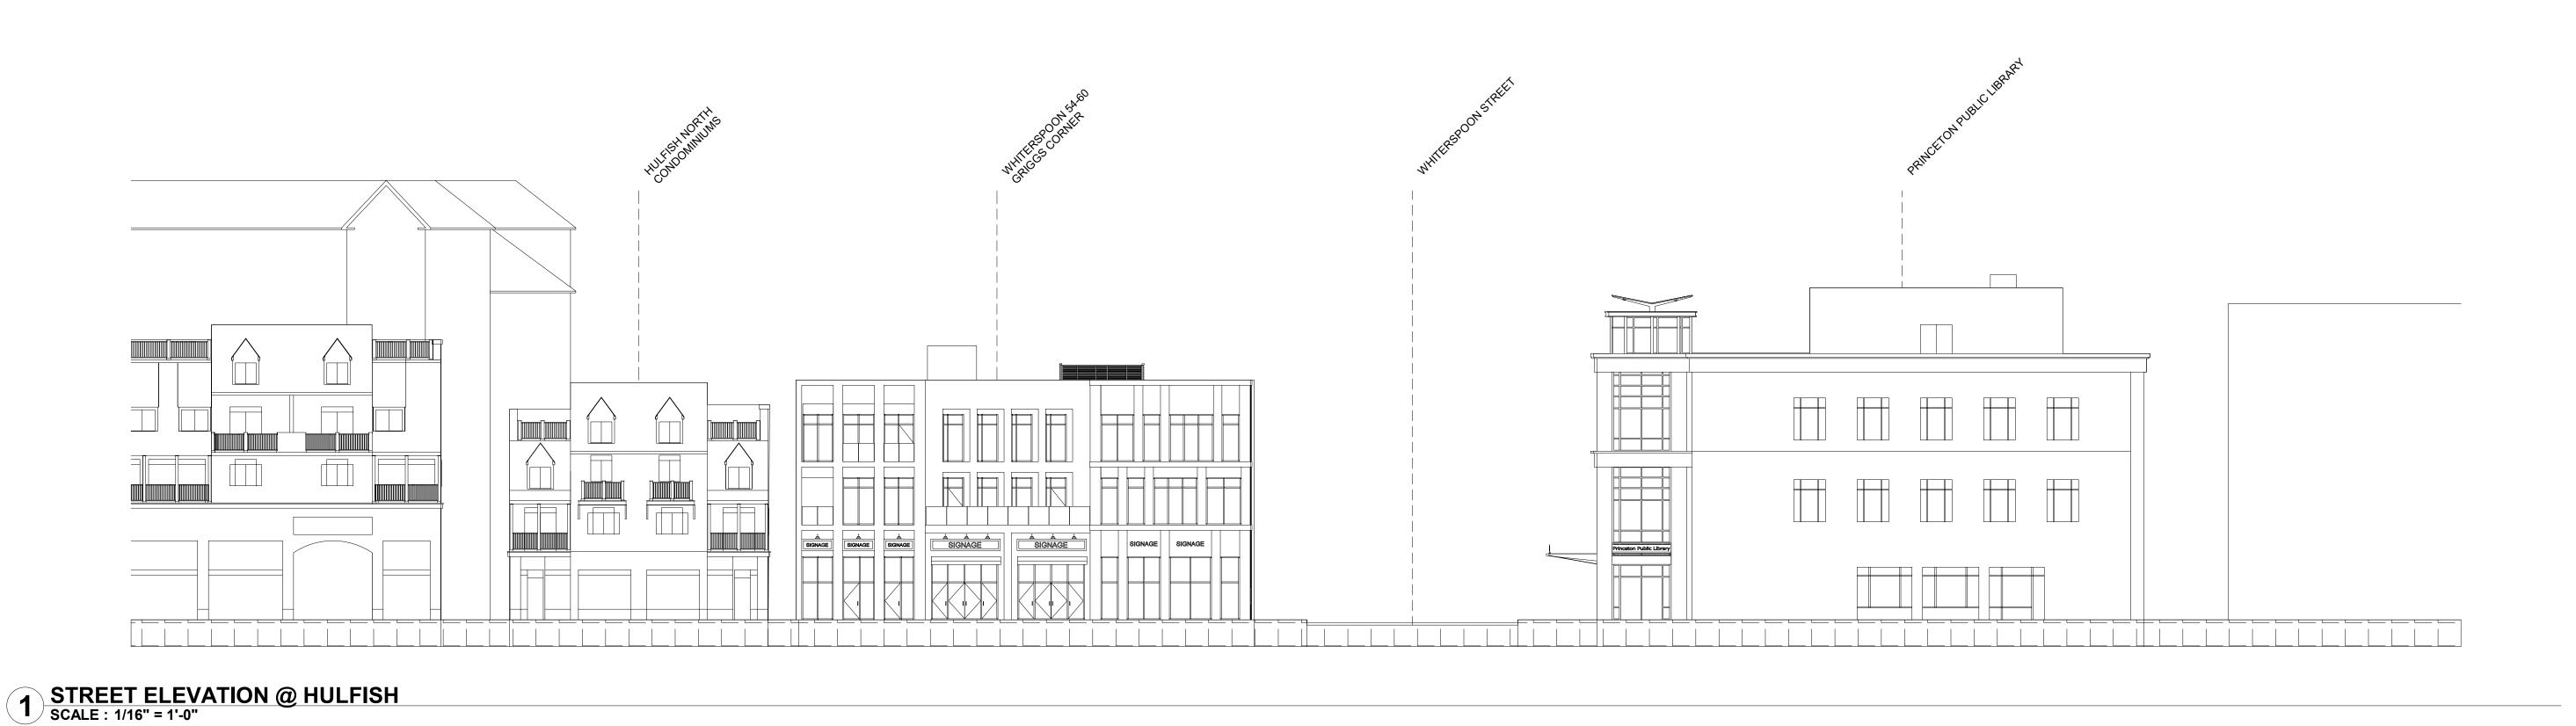
**ROOF PLAN** 


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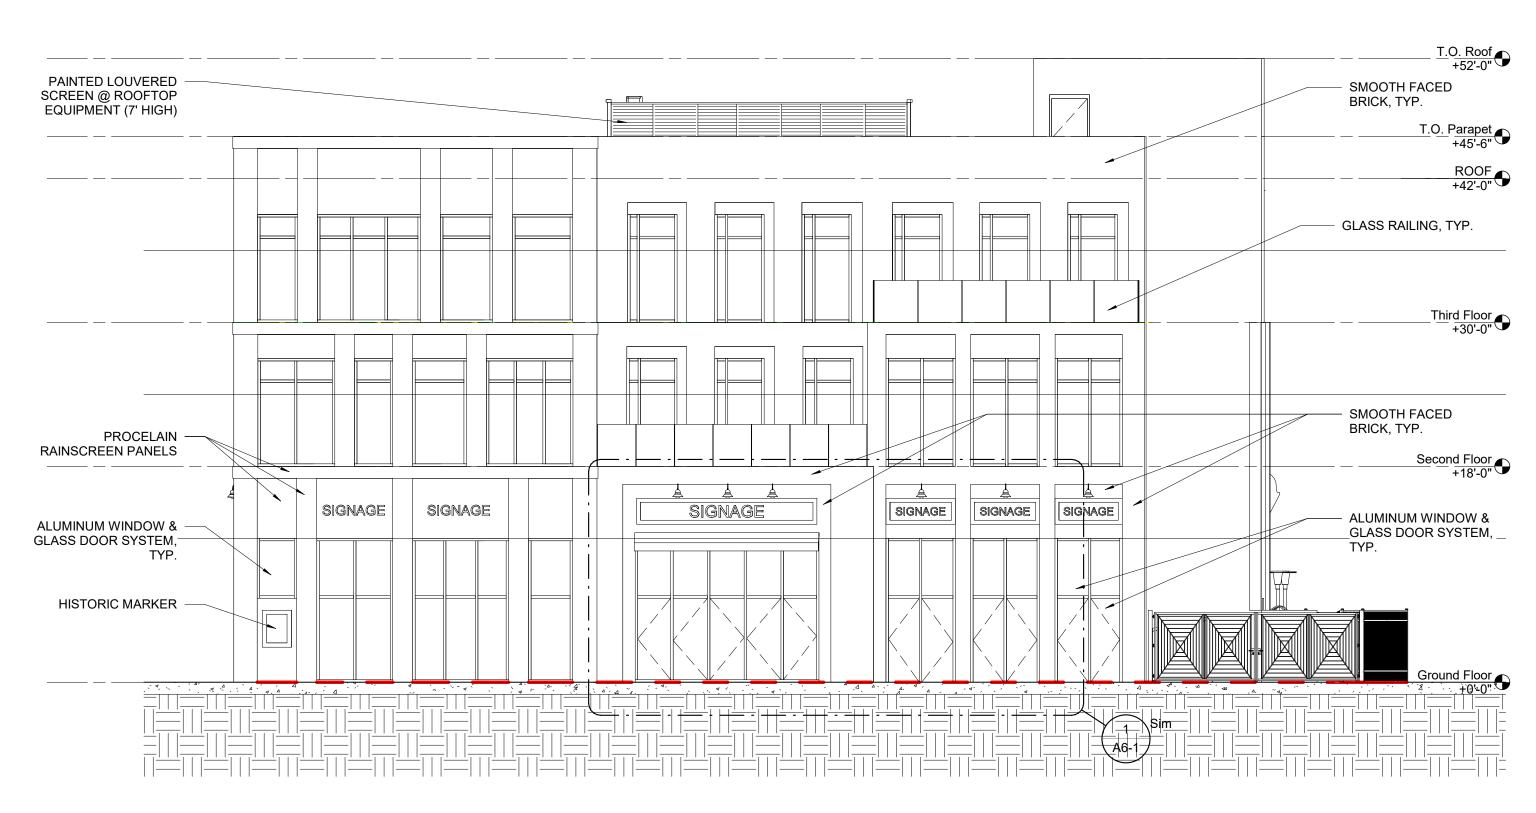
DRAWING NAME

SITE ELEVATIONS

PROJECT NO.: 21920 12-23-2019 SCALE: As indicated

SHEET NUMBER

**A3-1** 

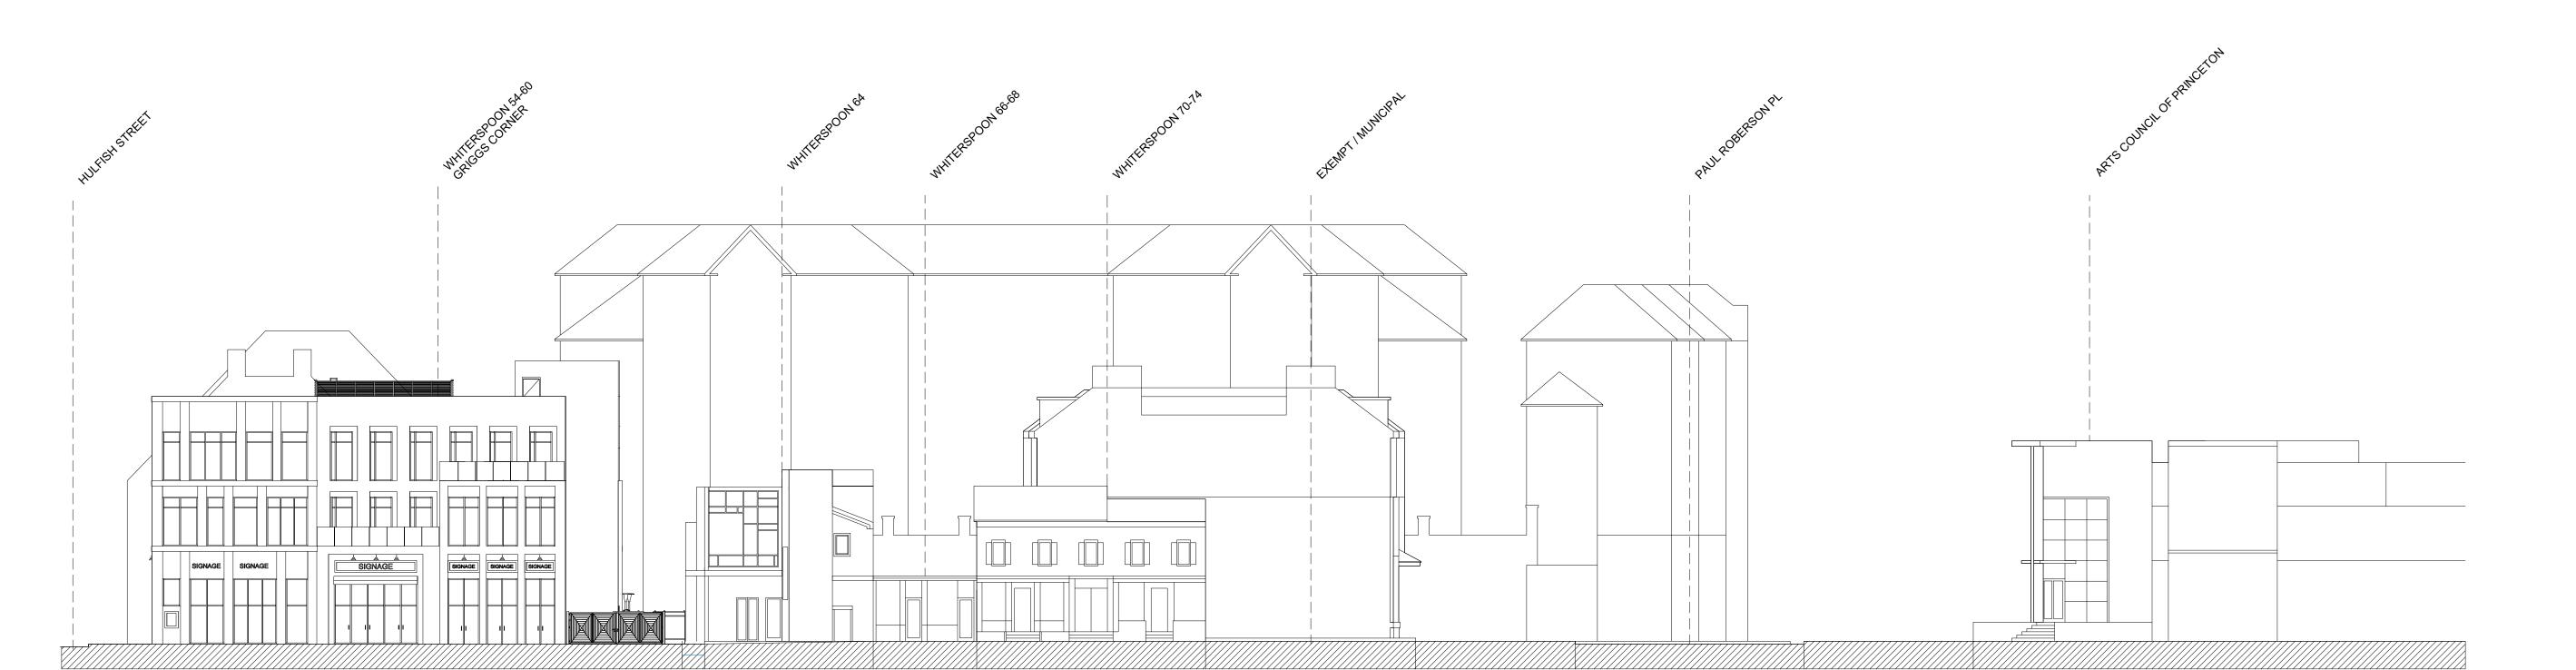

1 EAST ELEVATION SCALE: 1/8" = 1'-0"



4 SOUTH ELEVATION SCALE: 1/8" = 1'-0"

#### FINISH NOTES

SMOOTH FACED, ROMAN MAXIMUS BRICK. GRADE SW. BASIS OF DESIGN FOR COLOR:

SONOMA VALLEY COLONIAL BY SIOUX CITY BRICK SMOOTH FACED, ROMAN MAXIMUS BRICK. GRADE SW. BASIS OF DESIGN FOR COLOR: SANDFORD ENGINEER BY GLEN-GERY.

PORCELAIN TILE RAINSCREEN FACADE. BASIS OF DESIGN: CITY CUBE BY PORCELANOSA.

PORCELAIN TILE RAINSCREEN FACADE & TRIM. BASIS OF DESIGN: CITY ZONE BY WOOD-LOOK PORCELAIN TILE PAVERS. BASIS OF DESIGN: PORCELAINGRES DE\_TILES, TL-03 =

IN WOOD CANELETTO COLLECTION, COLOR TO BE SELECTED. CONCRETE-LOOK PORCELAIN TILE PAVERS. CEMENT RESIN EFFECT PORCELAIN TILE PAVERS. BASIS OF DESIGN: ARTISTEA, CM2 CON.CREA. CM2 EARTH COLLECTION, COLOR

SUNBRELLA CLARITY. COLOR(S) TO BE SELECTED BY FUTURE TENANT(S).

INSULATED LOW-E GLASS. LAMINATED WINDOWS & DOORS.

TINTED CONCRETE TO MATCH MUNICIPAL STREETSCAPE STANDARDS.

CALIFORNIA STUCCO CIMENTITIOUS. COLOR TO BE SELECTED.

ANODIZED ALUMINUM BY ZERO. COLOR TO MATCH ARCHITECT'S SAMPLE.

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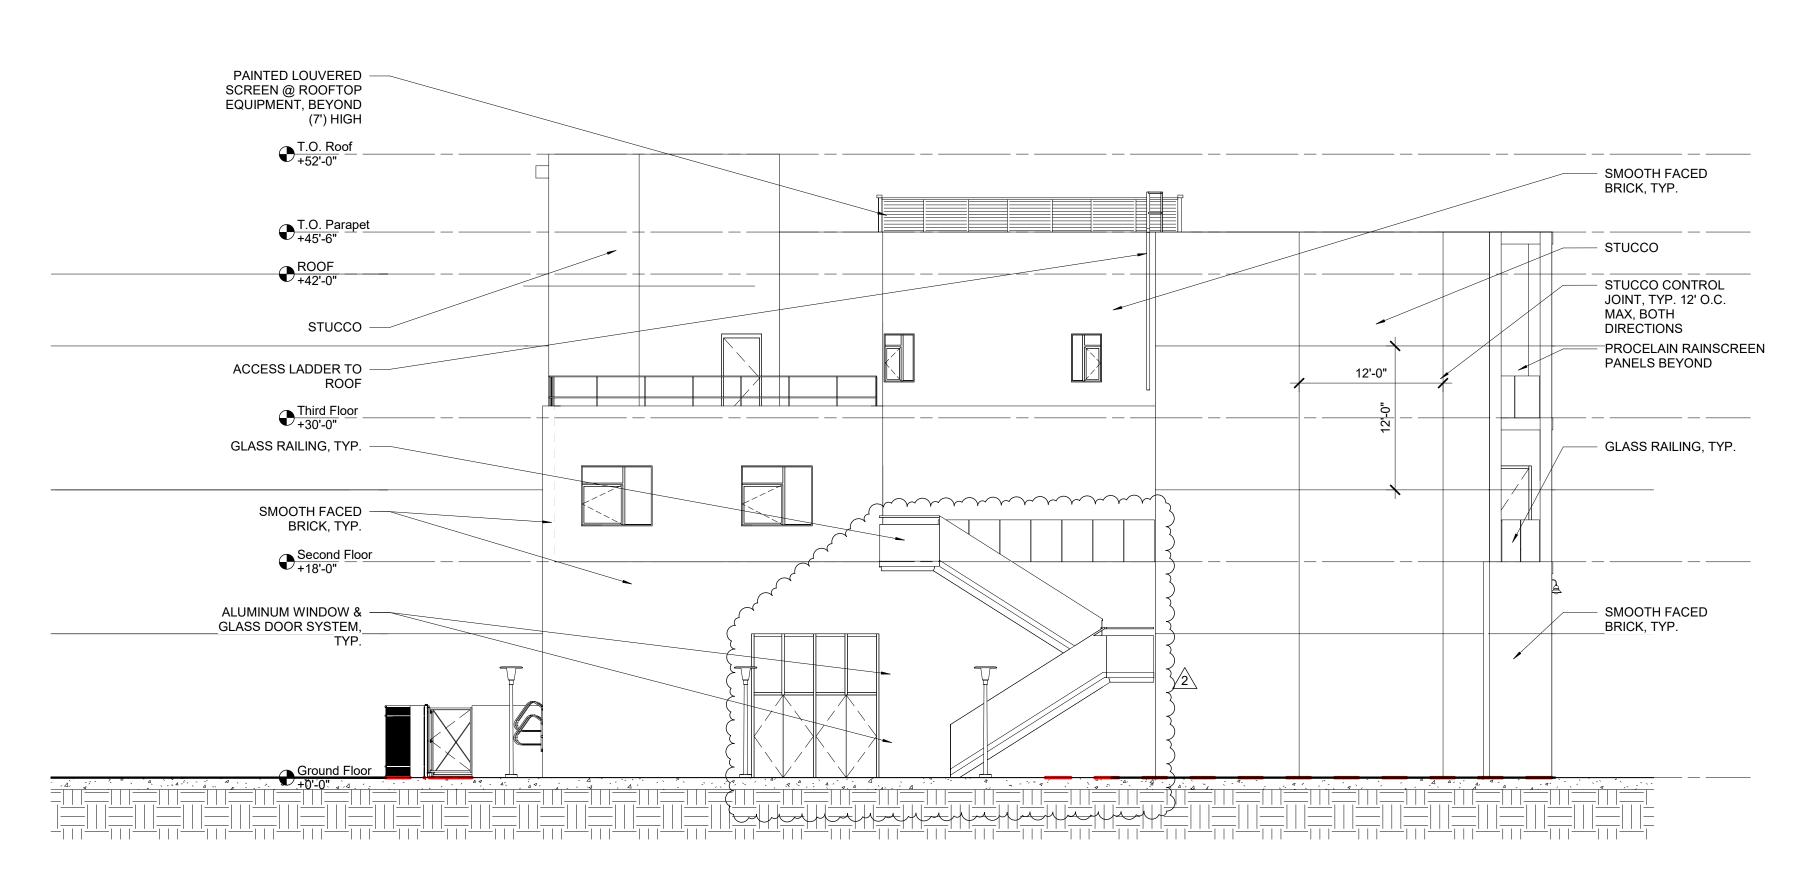
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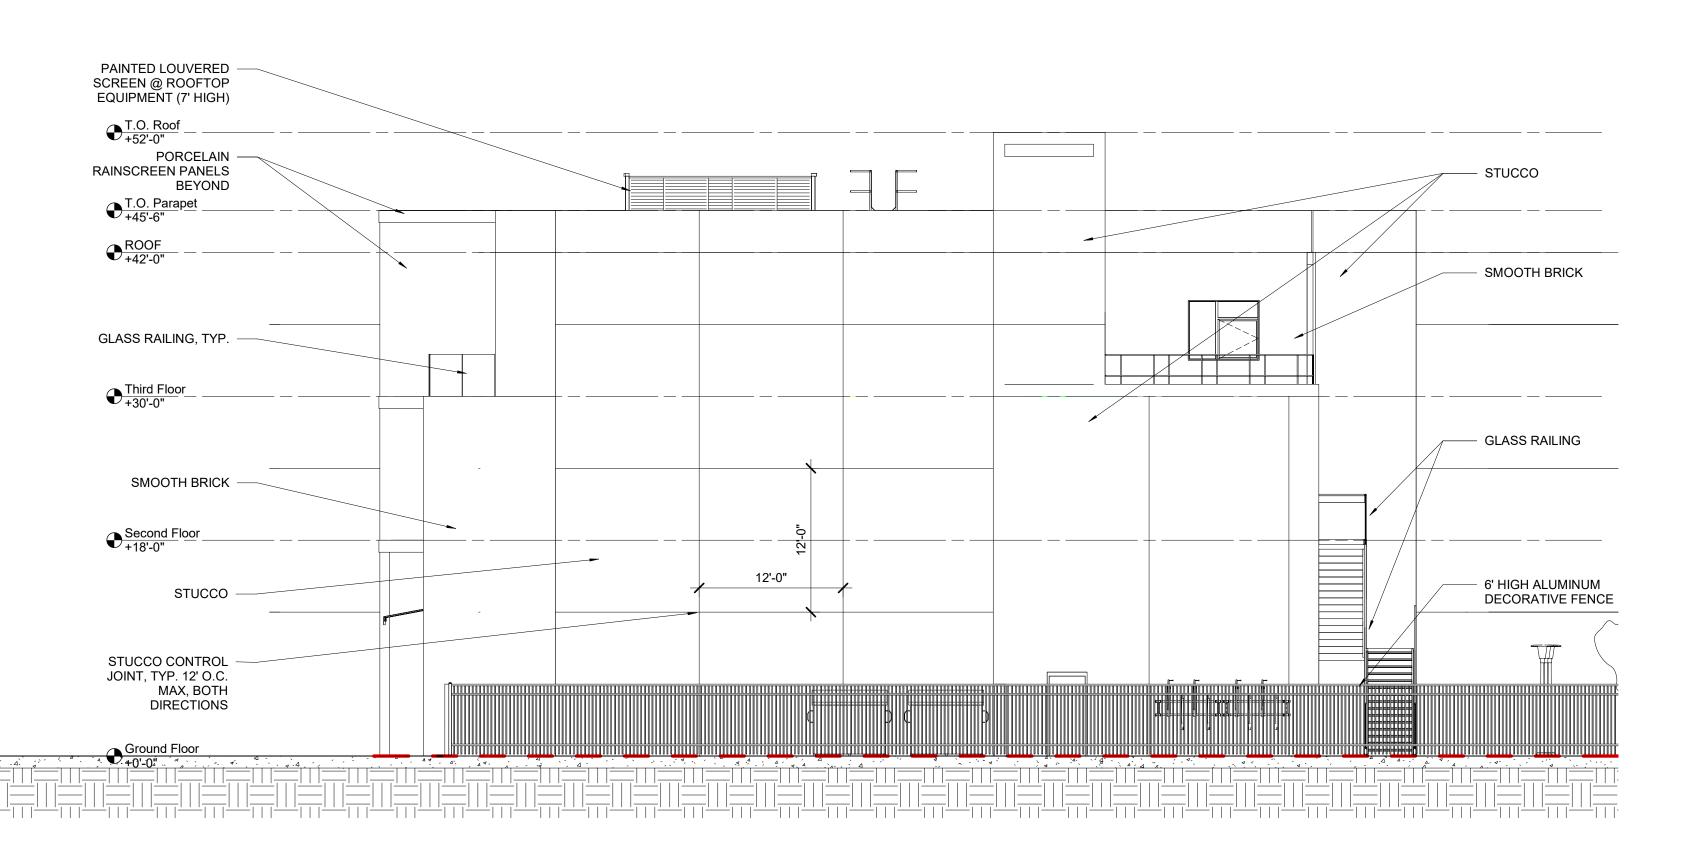
**EXTERIOR ELEVATIONS** 

DRAWN BY: JL, MP

PROJECT NO.: 21920 12-23-2019 SCALE: SHEET NUMBER



## 2 WEST ELEVATION SCALE: 1/8" = 1'-0"



1 NORTH ELEVATION SCALE: 1/8" = 1'-0" ARCHITECT

JZA+D

JOSHUA ZINDER ARCHITECTURE + DESIGN

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DATE: \_\_\_\_\_\_

GRIGG'S CORNER

STATE OF NEW JERSEY REGISTERED ARCHITECT JOSHUA B. ZINDER NJ 15316 PROJECT NAME

> 54-60 WITHERSPOON STREET PRINCETON, NJ 08542

> > DRAWING NAME

**EXTERIOR ELEVATIONS** 

DRAWN BY: JL, MP PROJECT NO.: 21920


DATE: 12-23-2019 SCALE: As indicate

SHEET NUMBER


**A3-3** 


# PTD. INCISED LETTERING AND BORDER COLOR: TBD 15'-0" - DASHED LINE INDICATES EXTENT OF 8.9 SF TEXT NOTE: 20 SF ALLOWABLE

# **3** WITHERSPOON LARGE SIGNBOARD ELEVATION SCALE: 3/4" = 1'-0"

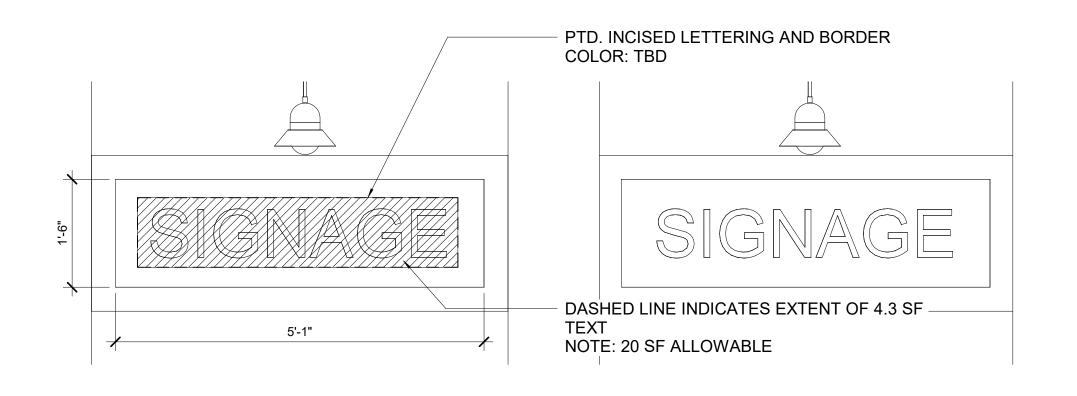


4 WITHERSPOON SMALL SIGNBOARD ELEVATION SCALE: 3/4" = 1'-0"

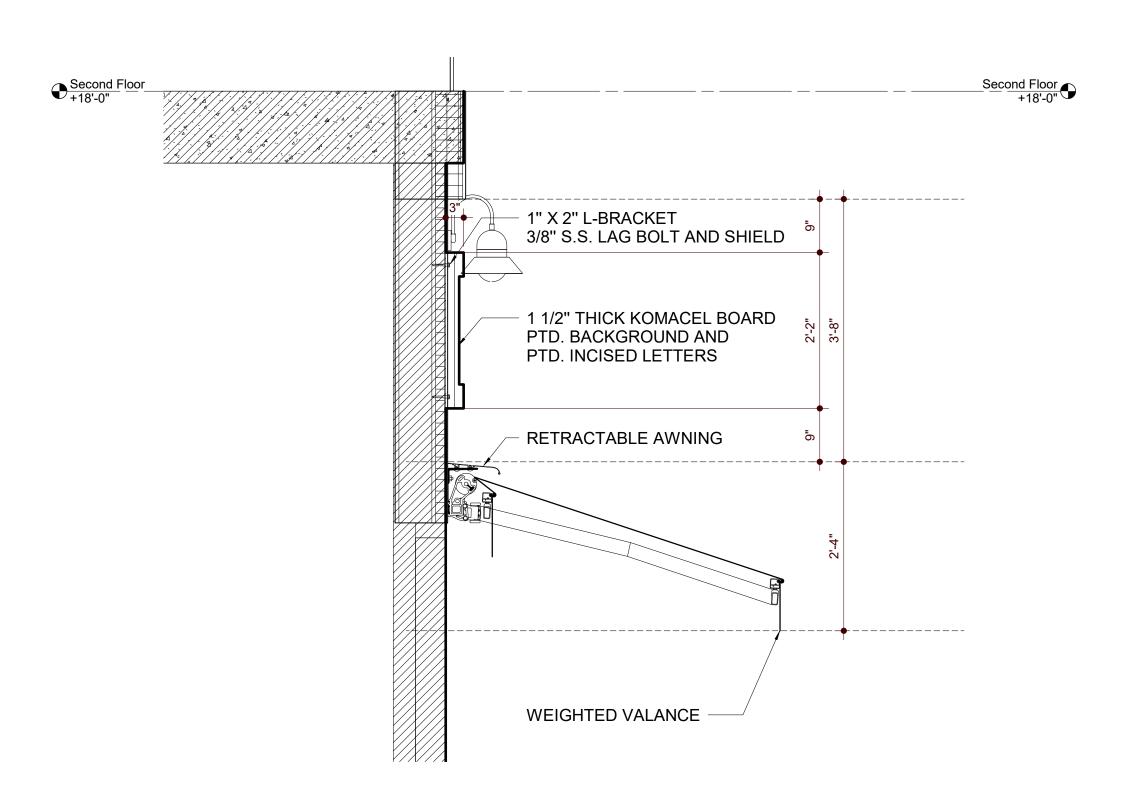

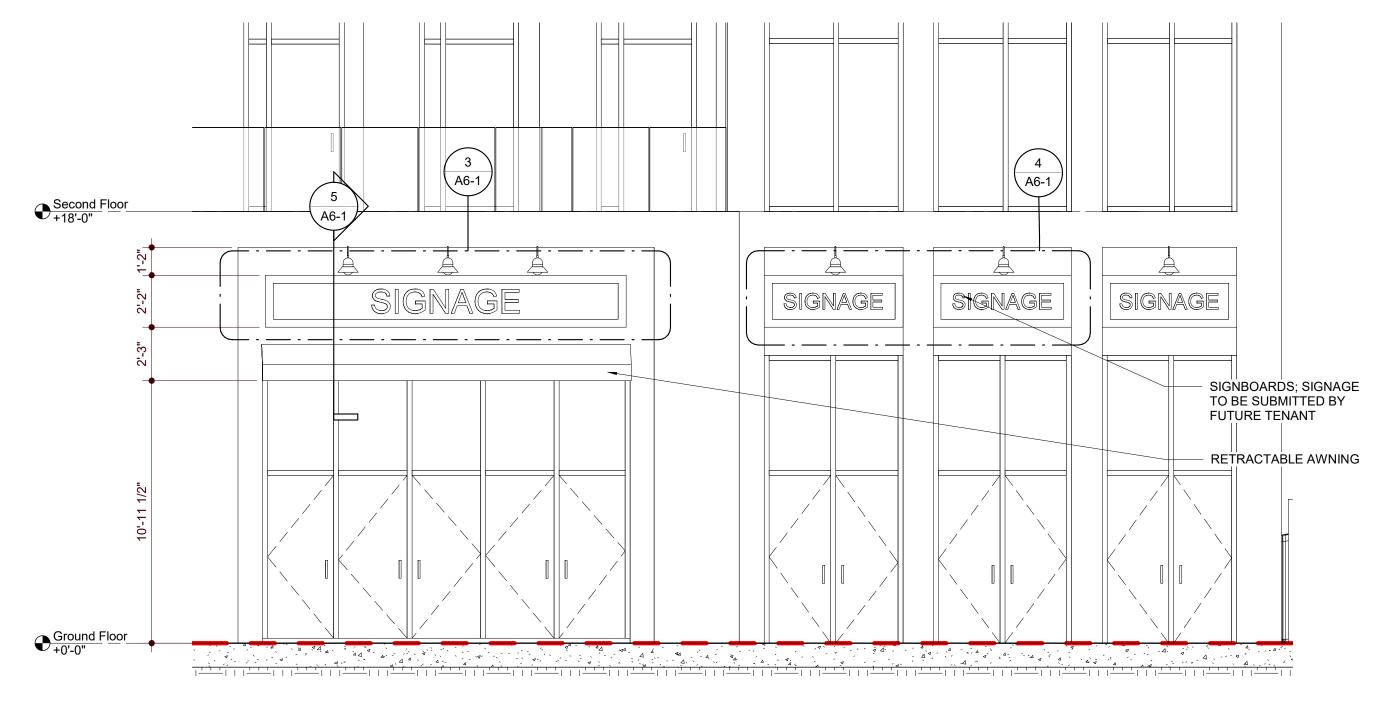

1 SIGNAGE @ WITHERSPOON FACADE SCALE: 1/4" = 1'-0"

2 SIGNAGE @ HULFISH FACADE SCALE: 1/4" = 1'-0"

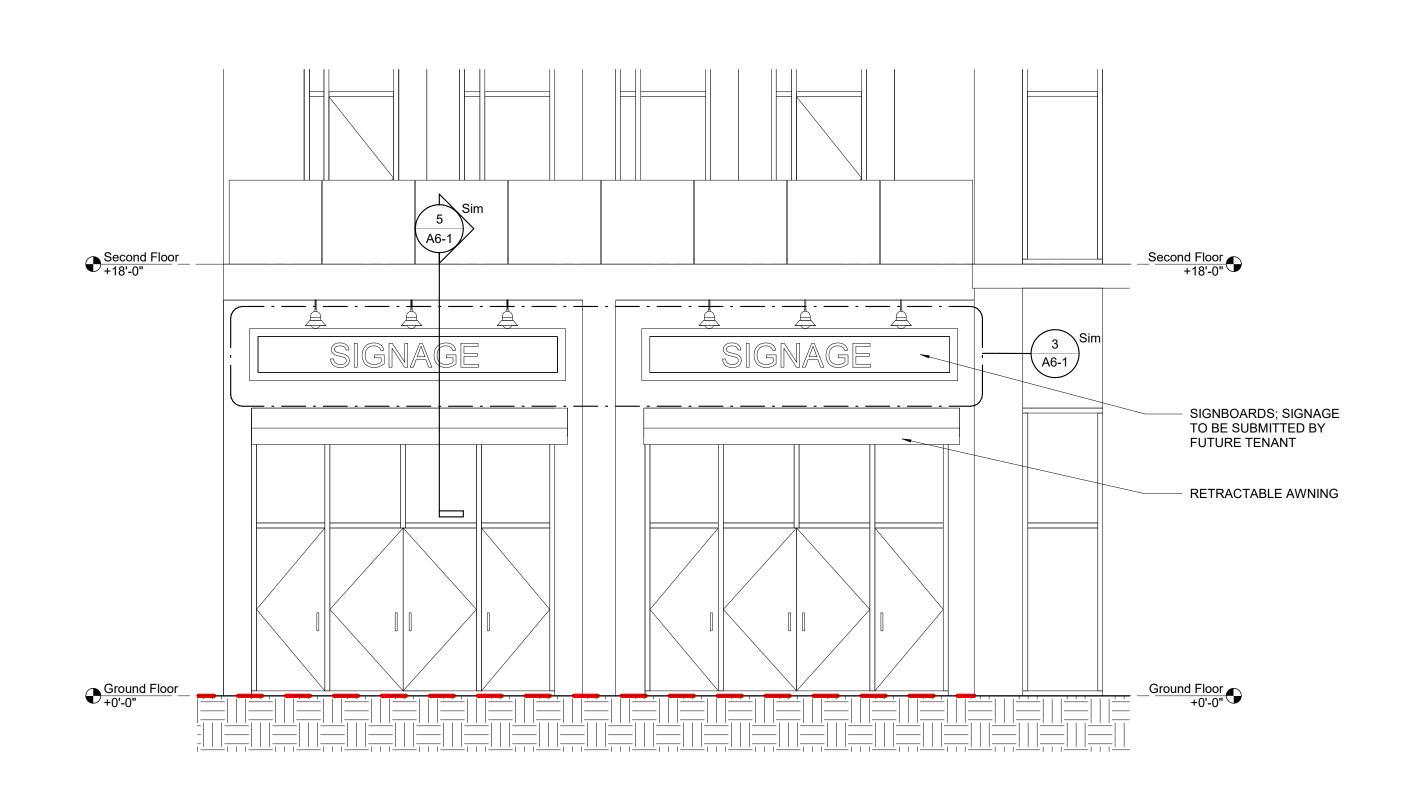

5 AWNING SECTION SCALE: 3/4" = 1'-0"

20 NASSAU STREET,

PRINCETON, (T) 609 924 5004 (F) 609 924 5008 CIVIL ENGINEER

**NEW JERSEY 08542** 

200 AMERICAN METRO BLVD. SUITE 114, HAMILTON, NJ 08619 T. 609.454.3433, F. 908.238.9572

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11-09-2020 MUNICIPAL REVIEW

ISSUED FOR

STATE OF NEW JERSEY REGISTERED ARCHITECT

JOSHUA B. ZINDER NJ 15316 PROJECT NAME

**GRIGG'S** CORNER

54-60 WITHERSPOON STREET PRINCETON, NJ 08542

DRAWING NAME

**SIGNAGE** 

JL, MP PROJECT NO.: 21920 12-23-2019 SCALE:

**A6-1** 

SHEET NUMBER

Product family datasheet

### LINEARlight POWER Flex Protect

LED modules for professional and industrial applications



Areas of application - Facade accent lighting Ceiling integration Wall integration Cove lighting Machine lighting Path lighting - Suitable for outdoor use

#### Product family benefits

- High luminous flux

December 16, 2019, 15:38:26

LINEARlight POWER Flex Protect

- Great design freedom thanks to flexibility and cuttability of module
- High-performance silicone for extremely long life and flexibility - Simple connection thanks to premounted connectors
- Extraordinary design and high quality materials
- Toolless connection with the optional CONNECT system – Easy mounting on many smooth surfaces thanks to self-adhesive tape at the back

### LIGHT FIXTURE TYPES:

THIS FIXTURE TYPE WILL BE RECESSED AS A COVE LIGHT ALONG THE BUILDING MASSING AT THE CORNER OF HULFISH & WITHERSPOON STREET. THE LIGHT FIXTURE WILL BE USED TO PROVIDE SOFT, ACCENT LIGHTING AND ILLUMINATION TO THE STREET CORNER.

### A Q L I G H T I N G

### Outdoor Gooseneck Sign Light - AQDLXS-930

#### DESCRIPTION

Voltage: 12V / 120V Socket Type: UL Certified Medium Base (E105933) 12v Bulb Type: A19 / M16 (with adapter) 120v Bulb Type: PAR30 / PAR38

Power Rating: 120W Max Mounting: Wall / Surface Weight: 4.69 lbs

Dimensions: H:20" x L:21.5" x D: 9.5"



6" & 12" arm extension, photocell, motion sensor

#### **DIMENSIONS**




**ACCESSORIES** 







ORDERING INFORMATION AQDLXS-930 **FINISH** 

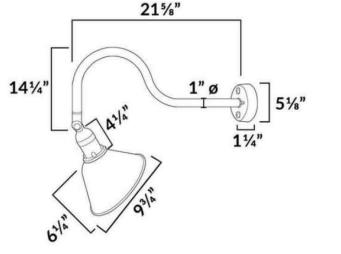

LIGHT FIXTURE TYPES:

& HULFISH STREETS.

THIS FIXTURE TYPE WILL BE USED TO ILLUMINATE THE PROPOSED FLAT SIGNAGE ON WITHERSPOON

WWND 10W Non-Dimmable Warm White 3000K LED
10W Non-Dimmable Cool White 5000K LED
9W Dimmable Warm White 3000K GU24 Puck Lamp LED
12W Dimmable Warm White 3000K GU24 Com Enclosed LED

AQDLXS-930 - \_\_\_\_\_- - \_\_\_\_ Fixture Type

Fresno Framed Medium Sconce

Item # CHD 2933AI-CG

Height: 17.75"

Extension: 9"

Finishes: Al

Wattage: 60 T

©EFC DESIGNS

Glass Options: CG

Socket: E26 Keyless

Width: 6"

Designer: Chapman & Myers

Backplate: 4.25" X 8" Rectangle

www.aqlightinggroup.com 800.865.7221





15w COB 1107 Lumens IP65 • Suitable For Wet Locations IK08 • Impact Resistant (Vandal Resistant)

**Mounting Detail** 

### LIGHT FIXTURE TYPES:


LIGHTING USA

UJE-30371

Jet 32 Square Surface



Weight 5.7 lbs

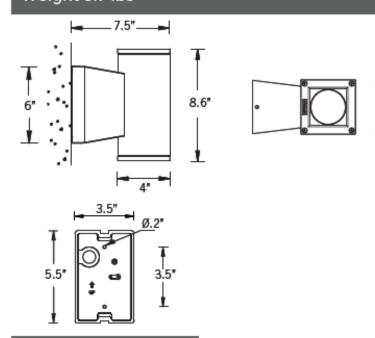

TYPE E: FIXTURE TYPE E IS TO BE USED AT THE EXTERIOR EGRESS DOOR ALONG THE NORTH ELEVATION ONLY, TO PROVIDE REQUIRED EGRESS ILLUMINATION. IT IS PROVIDED WITH A SOLID HOUSING AT THE TOP AND SIDES, SO THAT THE LIGHT SOURCE IS NOT VISIBLE FROM

**SPEC SHEET** 



Fresno Post Light Item # CHO 7933AI-CG

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Designer: Chapman & Myers


Page 1 of 9

Height: 21" Width: 8" Base: 3" Round Post Cap Finishes: Al Glass Options: CG Socket: E26 Keyless Wattage: 60 T Note: UL Only

### LIGHT FIXTURE TYPES:

TYPEX C & D:

FIXTURE TYPES C & D ARE A PART OF THE SAME COLLECTION. TYPE C, TO THE LEFT, WILL BE USED TO PROVIDE GENERAL ILLUMINATION TO THE BACK GRADE LEVEL COURTYARD ON POSTS. TYPE D, TO THE RIGHT, WILL BE USED TO PROVIDE GENERAL ILLUMINATION TO THE RESIDENTIAL ENTRY AT GRADE, TO THE AMENITY SECOND-LEVEL TERRACE, AND TO THE DWELLING UNIT OPEN-AIR BALCONIES AS SCONCES.

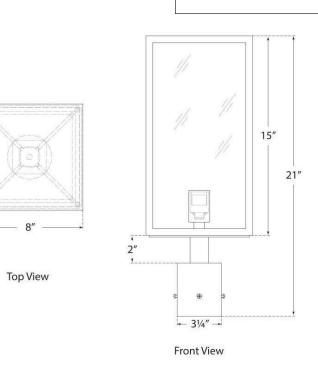

circa LIGHTING®

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**SPEC SHEET** 

NEIGHBORING PROPERTIES. ALL ILLUMINATION IS DIRECTED DOWNWARDS TO THE GROUND PLANE.

**A6-2** 

SHEET NUMBER

PROJECT NO.: 21920

SCALE: As indicated

JL, MP

12-23-2019

20 NASSAU STREET, PRINCETON, (T) 609 924 5004

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